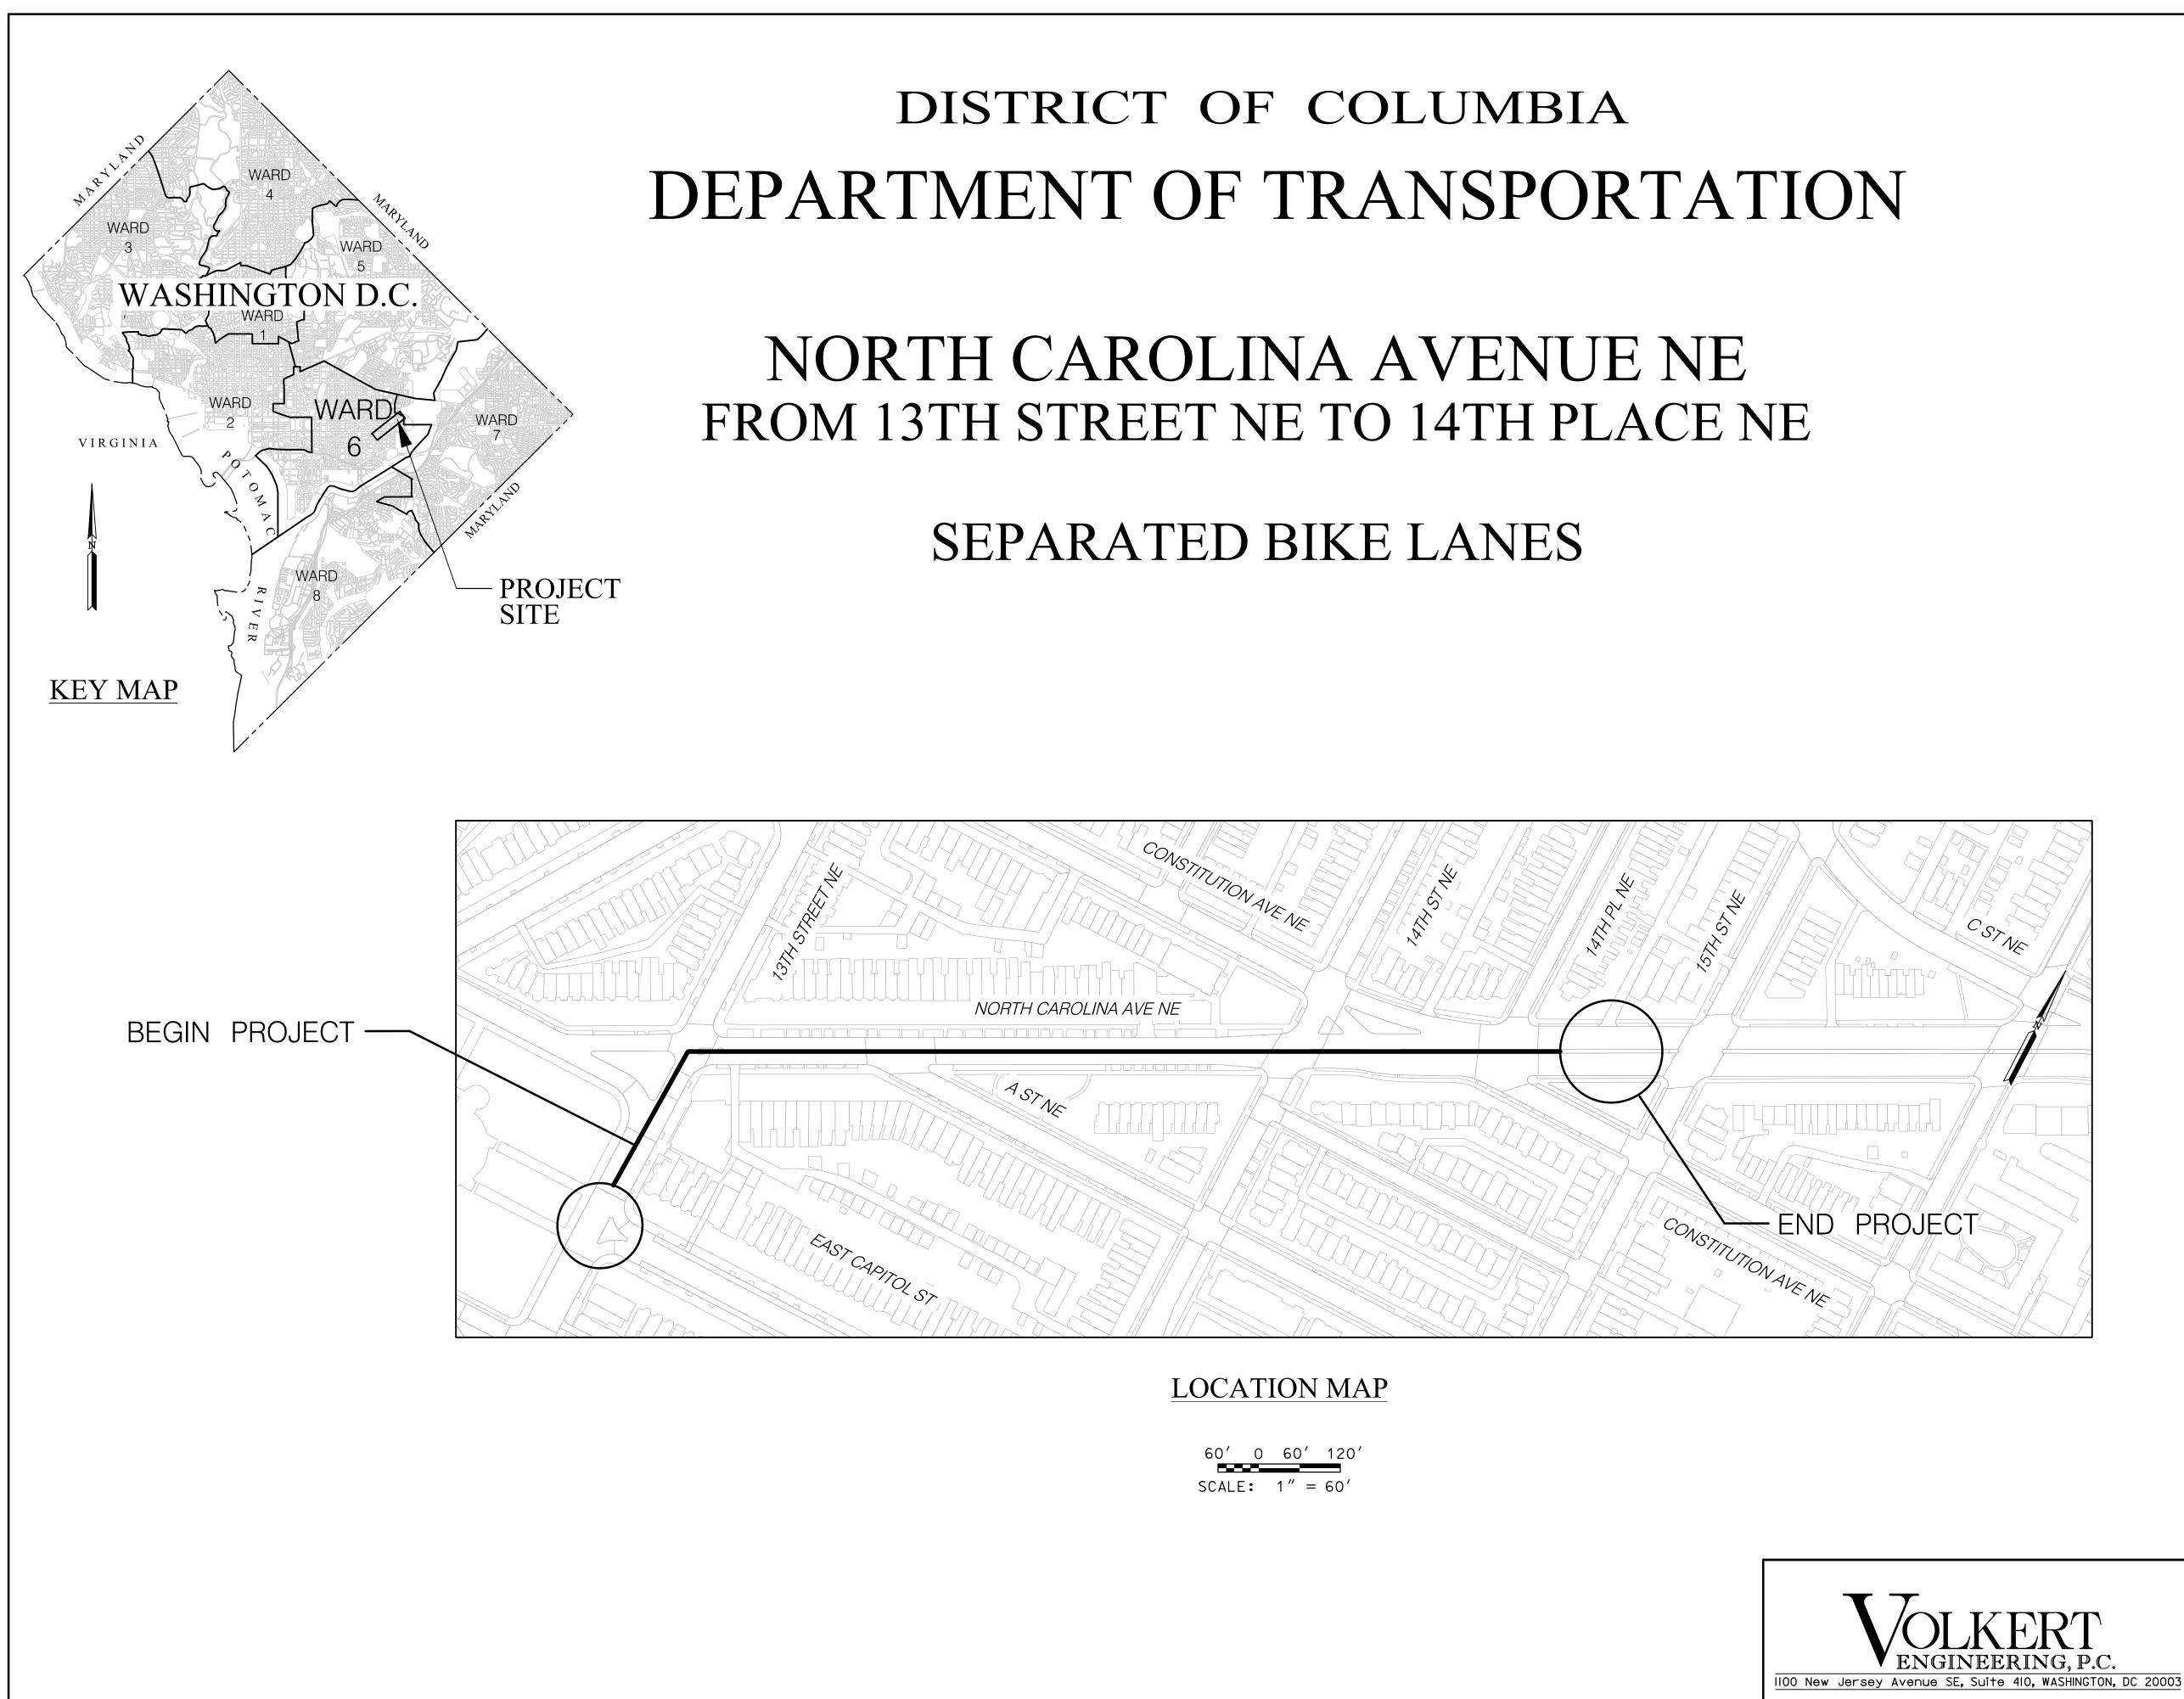
AGENDA ANC 6A Transportation & Public Space Committee Meeting Monday, December 19, 2022 at 7:00 pm Virtual Meeting via Zoom For those attending via Zoom: use this link: <u>https://us06web.zoom.us/j/81762512954</u> Call-in Number: 1 301 715 8592 Webinar ID (access code): 817 6251 2954 One tap mobile: +16465588656,,81762512954# Public Meeting – All are welcome

Community comment welcome; may be limited to 2 minutes to provide a chance for everyone to speak. Community comment time will be opened after each Old and New Business item.

- I. Call meeting to order.
- II. Introductions & Announcements (5 minutes)
- III. Old Business
 - A. 9th/K Streets NE pedestrian fatality. The DDOT Vision Zero team will discuss the fatal car crash that killed a pedestrian in November 2002 and actions to prevent additional fatalities.
 - B. 1300 block of North Carolina Avenue NE project (traffic calming/protected bike lanes). Will Handsfield from DDOT will discuss final design.
- IV. New Business
- V. Additional Community Comment (time permitting)
- VI. Adjourn meeting



	NO.	SHEETS
STP – 2016 (032)	1	32
	STP – 2016 (032)	STP - 2016 (032) 1

DISTRICT OF COLUMBIA DEPARTMENT OF TRANSPORTATION

RECOMMENDED FOR APPROVAL:

PROGRAM MANAGER DDOT; IPMD APPROVED:

CHIEF ENGINEER

DATE: _____

SHEET NO.	DWG.	TITLE
		<u>GENERAL (G)</u>
1	G-1	TITLE SHEET / LOCATION MAP / TRAFFIC DATA
2	G - 2 G - 3	INDEX OF DRAWINGS - 1 STANDARD SYMBOLS AND ABBREVIATIONS
3 4	G - 3 G - 4	STANDARD STMBOLS AND ABBREVIATIONS SUMMARY OF QUANTITIES - 1
5	G - 5	HORIZONTAL ALIGNMENT DATA
		ROADWAY (P)
6	P - 1	PAVEMENT PLAN - NORTH CAROLINA AVE
7	P - 2	PAVEMENT PLAN - NORTH CAROLINA AVE - STA. 92+00.00 TO STA. 97+00.00
8	P - 3	PAVEMENT PLAN - NORTH CAROLINA AVE - STA. 97+00.00 TO STA. 103+50.00
9	P - 4	CURB RAMP DETAILS - 1
10	P - 5	CURVE RETURN TABLES -1
		MAINTENANCE OF TRAFFIC (MT)
11	MT - 1	MAINTENANCE OF TRAFFIC - GENERAL NOTES AND SEQUENCE OF CONSTRUCTION
12	MT - 2	MAINTENANCE OF TRAFFIC - QUANTITIES
13	MT - 3	MAINTENANCE OF TRAFFIC PLAN - PHASE 1 NORTH CAROLINA AVE
14	MT - 4	MAINTENANCE OF TRAFFIC PLAN - PHASE 1 NORTH CAROLINA AVE - STA. 92+00.00 TO STA. 97+00.00
15	MT - 5	MAINTENANCE OF TRAFFIC PLAN - PHASE 1 NORTH CAROLINA AVE STA. 97+00.00 TO STA. 103+00.00
16	MT - 6	MAINTENANCE OF TRAFFIC PLAN - PHASE 2 NORTH CAROLINA AVE
17	MT - 7	MAINTENANCE OF TRAFFIC PLAN - PHASE 2 NORTH CAROLINA AVE - STA. 92+00.00 TO STA. 97+00.00
18	MT - 8	MAINTENANCE OF TRAFFIC PLAN - PHASE 2 NORTH CAROLINA AVE STA. 97+00.00 TO STA. 103+00.00
19	MT - 9	TYPICAL TCP AND DETOUR PLAN
		SIGNS AND PAVEMENT MARKING (SM)
20	SM - 1	SIGNS AND PAVEMENT MARKING PLAN - NORTH CAROLINA AVE
21	SM - 2	SIGNS AND PAVEMENT MARKING PLAN - NORTH CAROLINA AVE
22	SM - 3	SIGNS AND PAVEMENT MARKING PLAN - NORTH CAROLINA AVE
23	SM - 4	CROSSWALK DETAIL
24	SM - 5	PERMANENT SIGN SCHEDULE
	/	TRAFFIC SIGNAL PLANS (SG)
25	SG - 1	13TH STREET, EAST CAPITOL STREET, AND NORTH CAROLINA AVE NE TRAFFIC SIGNAL MODIFICATION - STAGE
26	SG - 2	13TH STREET, EAST CAPITOL STREET, AND NORTH CAROLINA AVE NE TRAFFIC SIGNAL MODIFICATION - FINAL
27 28	SG - 3 SG - 4	13TH STREET, EAST CAPITOL STREET, AND NORTH CAROLINA AVE NE TRAFFIC SIGNAL MODIFICATION - CABLE 13TH STREET, EAST CAPITOL STREET, AND NORTH CAROLINA AVE NE TRAFFIC SIGNAL MODIFICATION - UTILIT
28 29	SG - 4 SG - 5	14TH STREET, NORTH CAROLINA AVENUE, AND CONSTITUTION AVENUE, NE TRAFFIC SIGNAL MODIFICATION - UTILIT
29 30	SG - 5 SG - 6	14th STREET, NORTH CAROLINA AVENUE, AND CONSTITUTION AVENUE, NE TRAFFIC SIGNAL MODIFICATION -
30 31	SG - 7	14th STREET, NORTH CAROLINA AVENUE, AND CONSTITUTION AVENUE, NE TRAFFIC SIGNAL MODIFICATION -
31	3G - 7 SG - 8	14th STREET, NORTH CAROLINA AVENUE, AND CONSTITUTION AVENUE, NE TRAFFIC SIGNAL MODIFICATION -
52		

INDEX OF DRAWINGS

- STAGE 1 FINAL - UTILITY ATION - STAGE TION - FINAL TION - CABLE



					G - 2	
				D.C. DEPARTMENT OF TRANSPORTATION INFRASTRUCTURE PROJECT MANAGEMENT ADMINISTRATION PROJECT MANAGEMENT DIVISION		
				NORTH CAROLINA AVE C STREET NE STREETSCAPE EXTENSION, 13TH ST NE TO 14 PL NE WARD 6 – WASHINGTON, D.C.	PROJECT ENG. <u>B. B.</u> DESIGNED BY CHECKED BY DRAWN BY PROJECT MGR. <u>B. B.</u>	
NO.	DESCRIPTION	NAME	DATE	INDEX OF DRAWINGS – 1	DIVISION CHIEF	
	REVISIONS				DWG. G – 2 OF G – 5	

REG	STATE	PROJECT	SHEET NO.	TOTAL SHEETS
3	D.C.	STP – 2016 (032)	2	32
			-	

	STANDARD SYN	MBOLS			ABBRI	EVIATIONS	REGSTATEPROJECTSHEET NO.TOTAL SHEETS3D.C.STP – 2016 (032)332
cs sd			XISTING GUIDERAIL SINGLE FACE ROPOSED GUIDERAIL SINGLE FACE	AASHTO AC ADA &	AMERICAN ASSOCIATION OF STATE HIGHWAY AND TRANSPORTATION OFFICIALS ASPHALT CONCRETE AMERICANS WITH DISABILITIES ACT	M.U.T.C.D MH/M.H. MAX. MIN.	MANHOLE MAXIMUM MINIMUM
(C) (S)	EXISTING GAS CUT-OFF EXISTING SANITARY SEWER MANHOLE		VIRECTION OF TRAFFIC XISTING SIGN AND POST	@ APPROX. AWG AVE. ASTM	AND AT APPROXIMATELY AMERICAN WIRE GAUGE AVENUE AMERICAN SOCIETY FOR TESTING MATERIALS	MOT MOD. N NE/N.E.	MAINTENANCE OF TRAFFIC MODIFICATION NORTH NORTH EAST
WM (W) IQII	EXISTING WATER METER EXISTING WATER CUT-OFF EXISTING FIRE HYDRANT		ROPOSED SIGN AND POST XISTING 20 FOOT TRAFFIC SIGNAL POLE	B.C. BFD	BASELINE BOLT CIRCLE BLOCK FLOW DIAGRAM	NEC N.T.S. NO. OR # NW/N.W.	NATIONAL ELECTRICAL CODES NOT TO SCALE
	PROPOSED FIRE HYDRANT	E	XISTING #16 STREETLIGHT POLE	BOT.	BLOCK FLOW DIAGRAM BOTTOM	O.C.	ON CENTER
S W SAN SD	EXISTING STORM, WATER OR SANITARY LINE LESS THAN 24"	- ++ 5	OCATION OF TEST BORINGS	CI C⁄CL. C.O. CONC.	CAST IRON CENTER LINE CLEAN OUT CONCRETE COMBINED SANITARY	PB P.C. P.T./P.O.T. PEPCO	POTOMAC ELECTRIC AND POWER COMPANY
E-G-T-CS-	EXISTING STORM, WATER OR SANITARY LINE 24" OR GREATER EXISTING UNDERGROUND ELECTRIC, GAS, TELEPHONE & COMBINED SEWER LINES	~	BREAK GRADE	CS CU. CY C-C/C TO C	CUBIC CUBIC YARD	PREF. P.G.L. P PL. PLA PCC	PREFORMED PROFILE GRADE LINE PLATE /PROPERTY LINE PLACE PLASTIC PORTLAND_CEMENT_CONCRETE
OHE	EXISTING OVERHEAD ELECTRIC PREVIOUSLY ABANDONED		PROPOSED 3'x3'x3' ELECTRICAL MANHOLE PROPOSED PENDANT POLE	DR. D.C./DC	DRIVE DISTRICT OF COLUMBIA DISTRICT OF COLUMBIA DEPARTMENT OF TRANSPORTATION	PSI PVC	POUNDS PER SQUARE INCH POLYVINYL CHLORIDE
	UNDERGROUND TO BE ABANDONED TO BE REMOVED		CURB INLET PROTECTION	DDOT DI DIA. DOE DWG. DCPDW DCMR	DISTRICT OF COLUMBIA DEPARTMENT OF TRANSPORTATION DUCTILE IRON DIAMETER DEPARTMENT OF ENVIRONMENT DRAWING /DRAWINGS DISTRICT OF COLUMBIA DEPARTMENT OF PUBLIC WORKS DISTRICT OF COLUMBIA MUNICIPAL REGULATION	R RD RT	RADIUS ROAD RIGHT
<u> </u>	BASE LINE EXISTING TREE (<9" DBH)	\sim	EXISTING TREE TO BE REMOVED		EAST /ELECTRIC	R.O.W. S SS SAN	RIGHT OF WAY SOUTH SANITARY SEWER SANITARY
•	EXISTING TREE (9"–20" DBH)	TP T	EXISTING TREE TO BE PROTECTED	E.F. E.W. EHA EL.⁄ELEV. EXIST. EXP.	EAST / ELECTRIC EACH FACE EACH WAY ENVIRONMENTAL HEALTH ASSOCIATION GROUP ELEVATION EXISTING EXPANSION	SAN. SE/S.E. SD SF SPEC SL SW/S.W.	SOUTH EAST STORM DRAIN SQUARE FEET SPECIFICATIONS STREET LIGHTING SOUTH WEST SIDEWALK
o	EXISTING TREE (>21 DBH)		PROPOSED TREE EXISTING SINGLE CATCH BASIN WITH FRIPLE THROAT ELONGATION	F.L.	FLOW LINE	STV STA. STD /ST D STL S.Y.	STREET STATION
E.V.	EXISTING ELECTRIC VAULT RIGHT OF WAY LINE		EXISTING SINGLE CATCH BASIN EXISTING QUALITY CATCH BASIN	F.O.D. FT. G	FULL OF DEBRIS FEET /FOOT GAS		
	DISTRICT OF COLUMBIA /MARYLAND STATE LINE PROPOSED RIGHT OF WAY LINE		PROPOSED SINGLE CATCH BASIN PROPOSED DOUBLE CATCH BASIN	GALV. GND.	GALVANIZED GROUND	T TC TYP. TS TRAV.	TELEPHONE TRAFFIC CONTROLLER TYPICAL TRAFFIC SIGNALS TRAVERSE
	EXISTING LOT LINE EXISTING FENCE	F	PROPOSED TRIPLE CATCH BASIN PROPOSED DOUBLE THROAT WATER QUALITY BASI	HB HR H.A.C.P. HPS	HAND BOX HOUR HOT ASPHALT CONCRETE PAVEMENT HIGH PRESSURE SODIUM	U.D.	UNDERDRAIN
-×× ⊠ _{TC}	PEOPOSED METAL FENCH WITH BRICK COLUMNS EXISTING TRAFFIC SIGNAL CONTROLLER	F I I I I I I I I I I I I I I I I I I I	PROPOSED WATER VALVE	I.D. IN. INC.	INSIDE DIAMETER INCH INCORPORATED	VAR. W W/ W/C	VARIES WEST /WATTS WITH WHEEL CHAIR WATER AND SEWER AUTHORITY
G T W (5) (5) (W)	EXISTING ELECTRIC, GAS, TELEPHONE & WATER MANHOLES PROPOSED SANITARY SEWER, STORMDRAIN, WATER MANHOL	7777777777777777777777777777777	PROPOSED LIMIT OF MAJOR WORK	JT./JTS. L /LUM. LBS LED LE	JOINT /JOINTS LUMINAIRE POUNDS LIGHT-EMITTING DIODE LINEAR FEET LUMP SUM LEFT	ŴC WASA WRPD	WATER AND SEWER AUTHORITY WRAPPED STEEL G-3
	EXISTING PEPCO MANHOLE EXISTING CATCH BASIN W/SAFETY GRATE		EXISTING LUMINAIRE AND SUPPORT ARM INDICATES DIRECTION OF LIGHT		LUMP SUM LEFT	IN	D.C. DEPARTMENT OF TRANSPORTATION
THB X	EXISTING TRAFFIC HAND BOX EXISTING 3' x3' x3' ELECTRICAL MANHOLE		PROPOSED LUMINAIRE AND SUPPORT ARM INDICATES DIRECTION OF LIGHT				PROJECT MANAGEMENT DIVISION NORTH CAROLINA AVE C STREET NE STREETSCAPE EXTENSION, 13TH ST NE TO 14 PL NE
	EXISTING 4'x4'x4' ELECTRICAL MANHOLE EXISTING PENDANT POLE		EXISTING WHEEL CHAIR/BICYCLE RAMP PROPOSED WHEEL CHAIR/BICYCLE RAMP	100 New Jersey Avenue SE, Suite 410, WASHINGTON		DATE	WARD 6 - WASHINGTON, D.C. DRAWN BY PROJECT MGRB.B. DIVISION CHIEF STANDARD SYMBOLS DATE AND ABBREVIATIONS FILE DWG. G - 3 OF G - 5 DWG. G - 3 OF G - 5

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SUMMARY OF QUANTITIES

FEM CODE	DESCRIPTION	UNIT	QUANTITY TOTAL
207002	TRENCH EXCAVATION AND BACKFILL	CY	28
308024	ADJUST WATER METER FRAME	EACH	2
310008	BASIN CONNECT PCC PIPE, CLASS III, 15 INCH	LF	16
310018	DOUBLE TYPE S BASIN	EACH	1
402010	HMA SURFACE COURSE, 12.5 MM	TON	10
403002	TACK COAT	SY	88
600011	FLEXIBLE CHANNELIZER POST	EACH	60
600025	INCIDENTAL CONSTRUCTION SPECIAL ITEM - SF - THERMOPLASTIC GREEN BICYCLE PAINT	SF	1450
605006	PCC SIDEWALK, 4 INCH	SY	91
605026	BRICK SIDEWALK ON PCC BASE	SY	73
606004	PCC CURB AND GUTTER	LF	66
606064	FURNISH AND SET 8"X12" GRANITE STRAIGHT CURB	LF	264
606066	FURNISH&SET 8"X12" GRANITE CIRCULAR CURB RADIUS UNDER 10FT	LF	47
606068	FURNISH&SET8"X12"GRANITE CIRCULAR CURB RADIUS10-100FT	LF	58
606070	FURJISH&SET8"X12"GRANITE CIRCULAR CURB RADIUS OVER 100FT	LF	24
606108	BRICK GUTTER	SF	163
607018	SOD WITH 3 INCH TOPSOIL	SY	144
612000	8' X 1.5' CONCRETE CURB BLOCK	EACH	1000
612005	PEDESTRIAN SAFETY BARRICADE	LF	60
612006	CONSTRUCTION LANE CLOSING	LS	1
612008	REMOVE LANE MARKINGS	SF	1700
612010	TEMPORARY CONSTRUCTION SIGN SUPPORTS	EACH	80
612014	CONSTRUCTION WARNING AND DETOUR SIGNS	SF	1340
612018	FLASHING AMBER WARNING LIGHTS, TYPE "B"	EACH	4
612022	SEQUENTIAL ARROW BOARDS	EACH	3
612028	TYPE III PVC BARRICADE	EACH	7
612034	TRAFFIC DRUMS	EACH	350
612054	THERMOPLASTIC PAVEMENT MARKING, 4 INCH		7650
612056	THERMOPLASTIC PAVEMENT MARKING, 4 INCH DASH	LF	1050
612058	THERMOPLASTIC PAVEMENT MARKING, 6 INCH		2090
612060	THERMOPLASTIC PAVEMENT MARKING, 6 INCH DASH		240
612064	THERMOPLASTIC PAVEMENT MARKING, 12 INCH		1390
612066	THERMOPLASTIC PAVEMENT MARKING, 24 INCH	LF	2250
612068	THERMOPLASTIC PAVEMENT LETTER	EACH	40
612070	THERMOPLASTIC PAVEMENT ARROW	EACH	20
612076	THERMOPLASTIC PAVEMENT BICYCLE MARKING, 8 FOOT	EACH	30
612100	PORTABLE CHANGEABLE MESSAGE SIGN	EACH	3
612112	PREFORMED PAVEMENT MARKINGS, SYMBOLS AND LETTERS	LF LF	200
612997	TRAFFIC CONTROL SPECIAL ITEM - LF - PAVEMENT MARKING TAPE, 4 INCH TRAFFIC CONTROL SPECIAL ITEM - LF - PAVEMENT MARKING TAPE, 6 INCH		3200 40
612997 612997	TRAFFIC CONTROL SPECIAL ITEM - LF - PAVEMENT MARKING TAPE, 6 INCH		60
613006	REMOVE ABANDONED TRAFFIC SIGNAL/STREET LIGHT POLE FOUNDATION	EACH	2
613008	F&I PCC FOUNDATION FOR TRAFFIC SIGNAL/STREET LIGHT FOLE FOUNDATION	EACH	1
613038	FURNISH&INSTALL ONE 2 IN&ONE 4 IN PVC ENCASED ELEC CONDUITS	LACIT	10
613054	FUR TEMP PORT CONC BASE 20 FT STEEL TRAF POLE ON TRANS BASE	EACH	10
613230	REMOVE EXISTING SIGNAL HEAD	EACH	5
613234	MAINTAIN EXISTING TRAFFIC SIGNALS DURING CONSTRUCTION	EACH	2
613238	F&I ACCESSIBLE PEDESTRIAN SIGNAL UNIT W/CUSTOM MESSAGING	EACH	1
613346	REMOVE ELECTRICAL CABLE (ANY TYPE)	LACH	1272
613352	REL ANY PEDEST SIGHEAD(12" LED MODULES)ONTO TEMP POLE ASMBLY	EACH	1
614993	RELOCATE EXISTING 8 FT MAST ARM W/CLAMP & REMOVABLE END CLAMP	EACH	1
614993	RELOCATE ANY ACCESSIBLE PEDESTRIAN SIGNAL (APS) PUSH BUTTON ONTO TEMP POLE	EACH	1
614993	COVER EXISTING TRAFFIC SIGNAL HEAD	EACH	1
614993	RELOCATE EXISTING 20 FOOT TALL STEEL TRAFFIC SIGNAL POLE ONTO NEW FOUNDATION	EACH	1
616018	METAL SIGN POSTS, 4.00 POUNDS PER FOOT	LACIT	340
616022	TRAFFIC SIGN PANELS	SF	230
		51	230



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				D.C. DEPARTMENT OF TRANSPOR INFRASTRUCTURE PROJECT MANAGEMENT AI PROJECT MANAGEMENT DIVIS	DMINISTRATION
				NORTH CAROLINA AVE C STREET NE STREETSCAPE EXTENSION, 13TH ST NE TO 14 PL NE WARD 6 – WASHINGTON, D.C.	PROJECT ENG. <u>B. B.</u> DESIGNED BY <u>P. K.</u> CHECKED BY <u>B. B.</u> DRAWN BY <u>P. K.</u> PROJECT MGR. <u>B. B.</u>
NO.	DESCRIPTION	NAME	DATE	SUMMARY OF QUANTITIES – 1	DIVISION CHIEF
	REVISIONS				FILE DWG. G – 4 OF G – 5

REG	STATE	PROJECT	SHEET NO.	TOTAL SHEETS
3	D.C.	STP – 2016 (032)	4	32

CONSTRUCTION BASELINE NORTH CAROLINA AVENUE Beginning chain NCAR_AVE description N 445,889.16 E 1,315,954.92 Sta 92+00.00 Point 5 Course from 5 to PC NCAR_AVE1 N 62° 29' 38.34" E Dist 1,410.03 Curve Data *----* Curve NCAR_AVE1 P.I. Station Delta = 27° 31′ 33.15″ Degree = 14° 19′ 26.20″ Tangent = 97.98 Length = 192.17 Radius = 400.00 External = 11.82 Long Chord = 190.32 Mid. Ord. = 11.48 P.C. Station 109+10.03 P.T. Station 111+02.20 C.C. Back = N 62° 29′ 38.34″ E Ahead = S 89° 58′ 48.51″ E Chord Bear = N 76° 15′ 24.92″ E 110+08.01 N 27° 31′ 33.15″ (RT) 14° 19′ 26.20″ 446,724.18 E 1,317,558.56 446,678.93 E 446,724.14 E 446,324.14 E 1,317,471.66 1,317,656.53 1,317,656.39 Ending chain NCAR_AVE description _____ CONSTRUCTION BASELINE CONSTITUTION AVENUE Beginning chain CONST_1 description N 446,253.81 E 1,316,307.68 Sta 8+50.00 Point 39 Course from 39 to 40 S 89° 58′ 13.71″ E Dist 150.00 N 446,253.63 E 1,316,654.88 Sta 11+97.20 Point 40 Ending chain CONST_1 description Beginning chain CONST_2 description N 446,253.63 E 1,316,654.88 Sta 10+00.00 Point 41 Course from 41 to 42 S 89° 58' 13.71" E Dist 200.00 Point 42 N 446,253.53 E 1,316,854.88 Sta 12+00.00 Ending chain CONST_2 description

CONSTRUCTION BASELINE 14TH STREET

Point 8	N	446,001.13 E	1,316,458.55 Sta	8+50.00
Course from 8 -	to 9 N 0° 11	′ 53.12″ W Dist 350	0.00	
Point 9	Ν	446,351.13 E	1,316,457.34 Sta	12+00.00

Ending chain 14_ST description

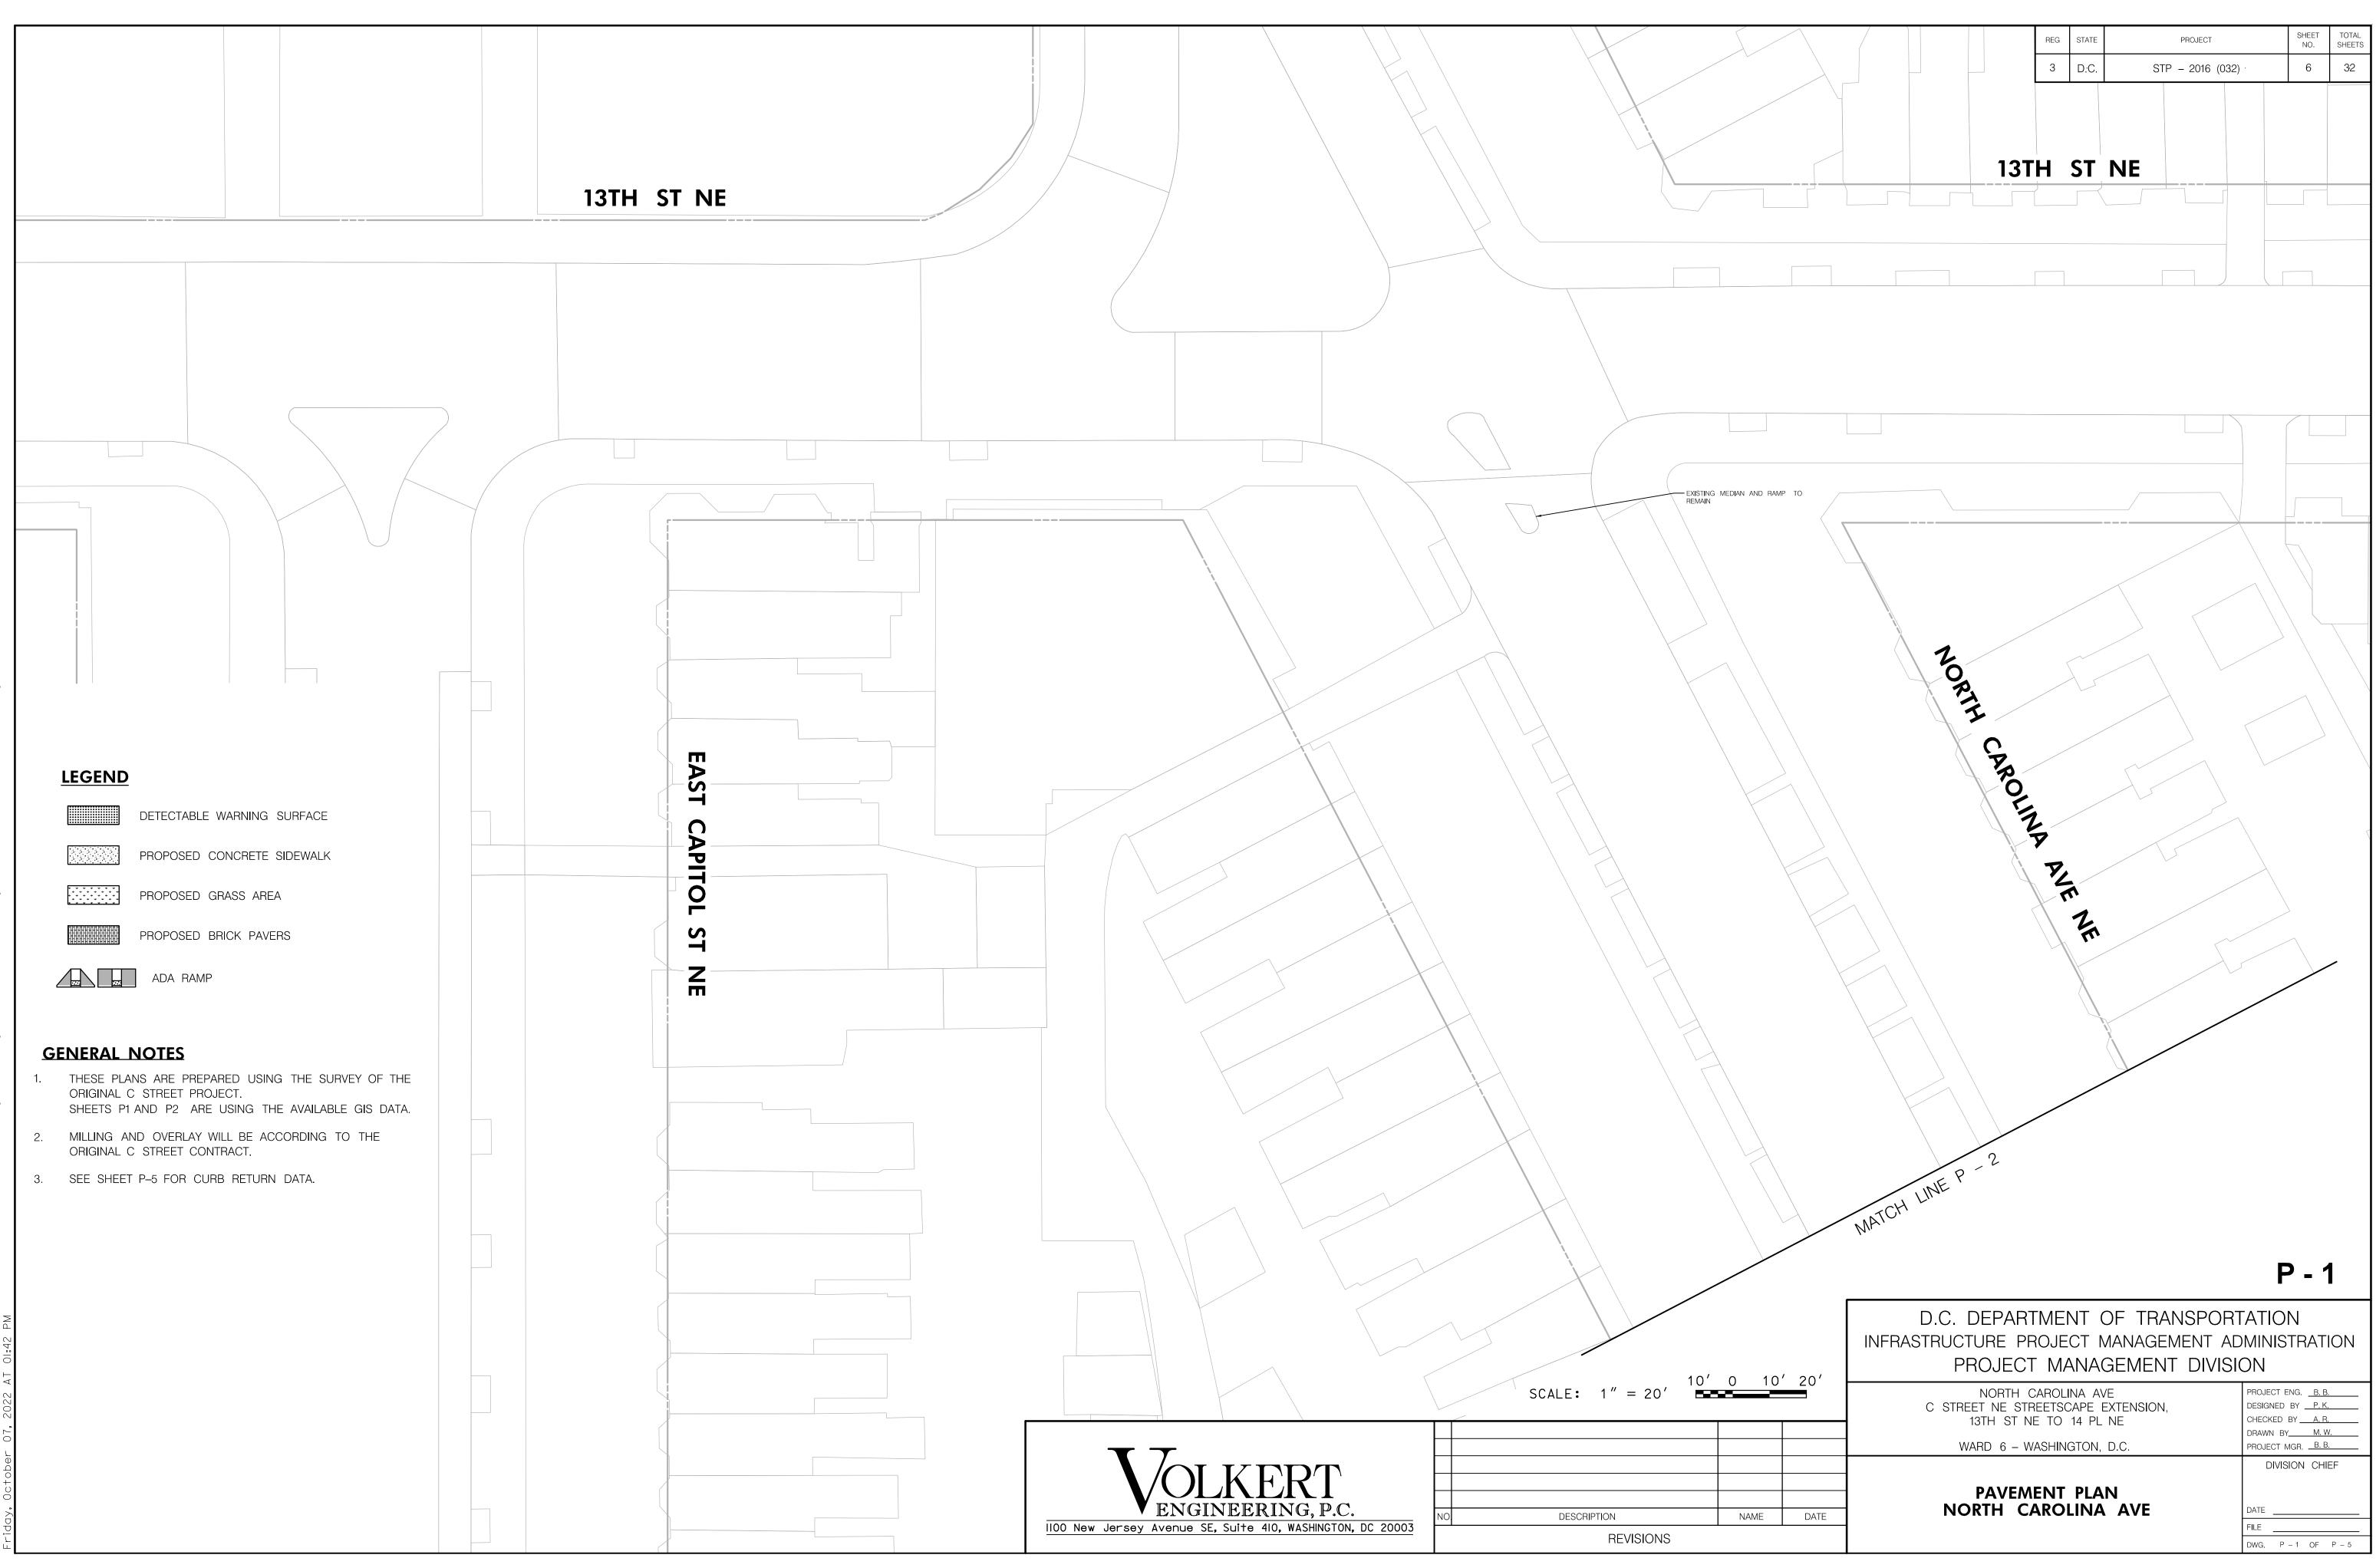
CONSTRUCTION BASELINE 14TH PLACE

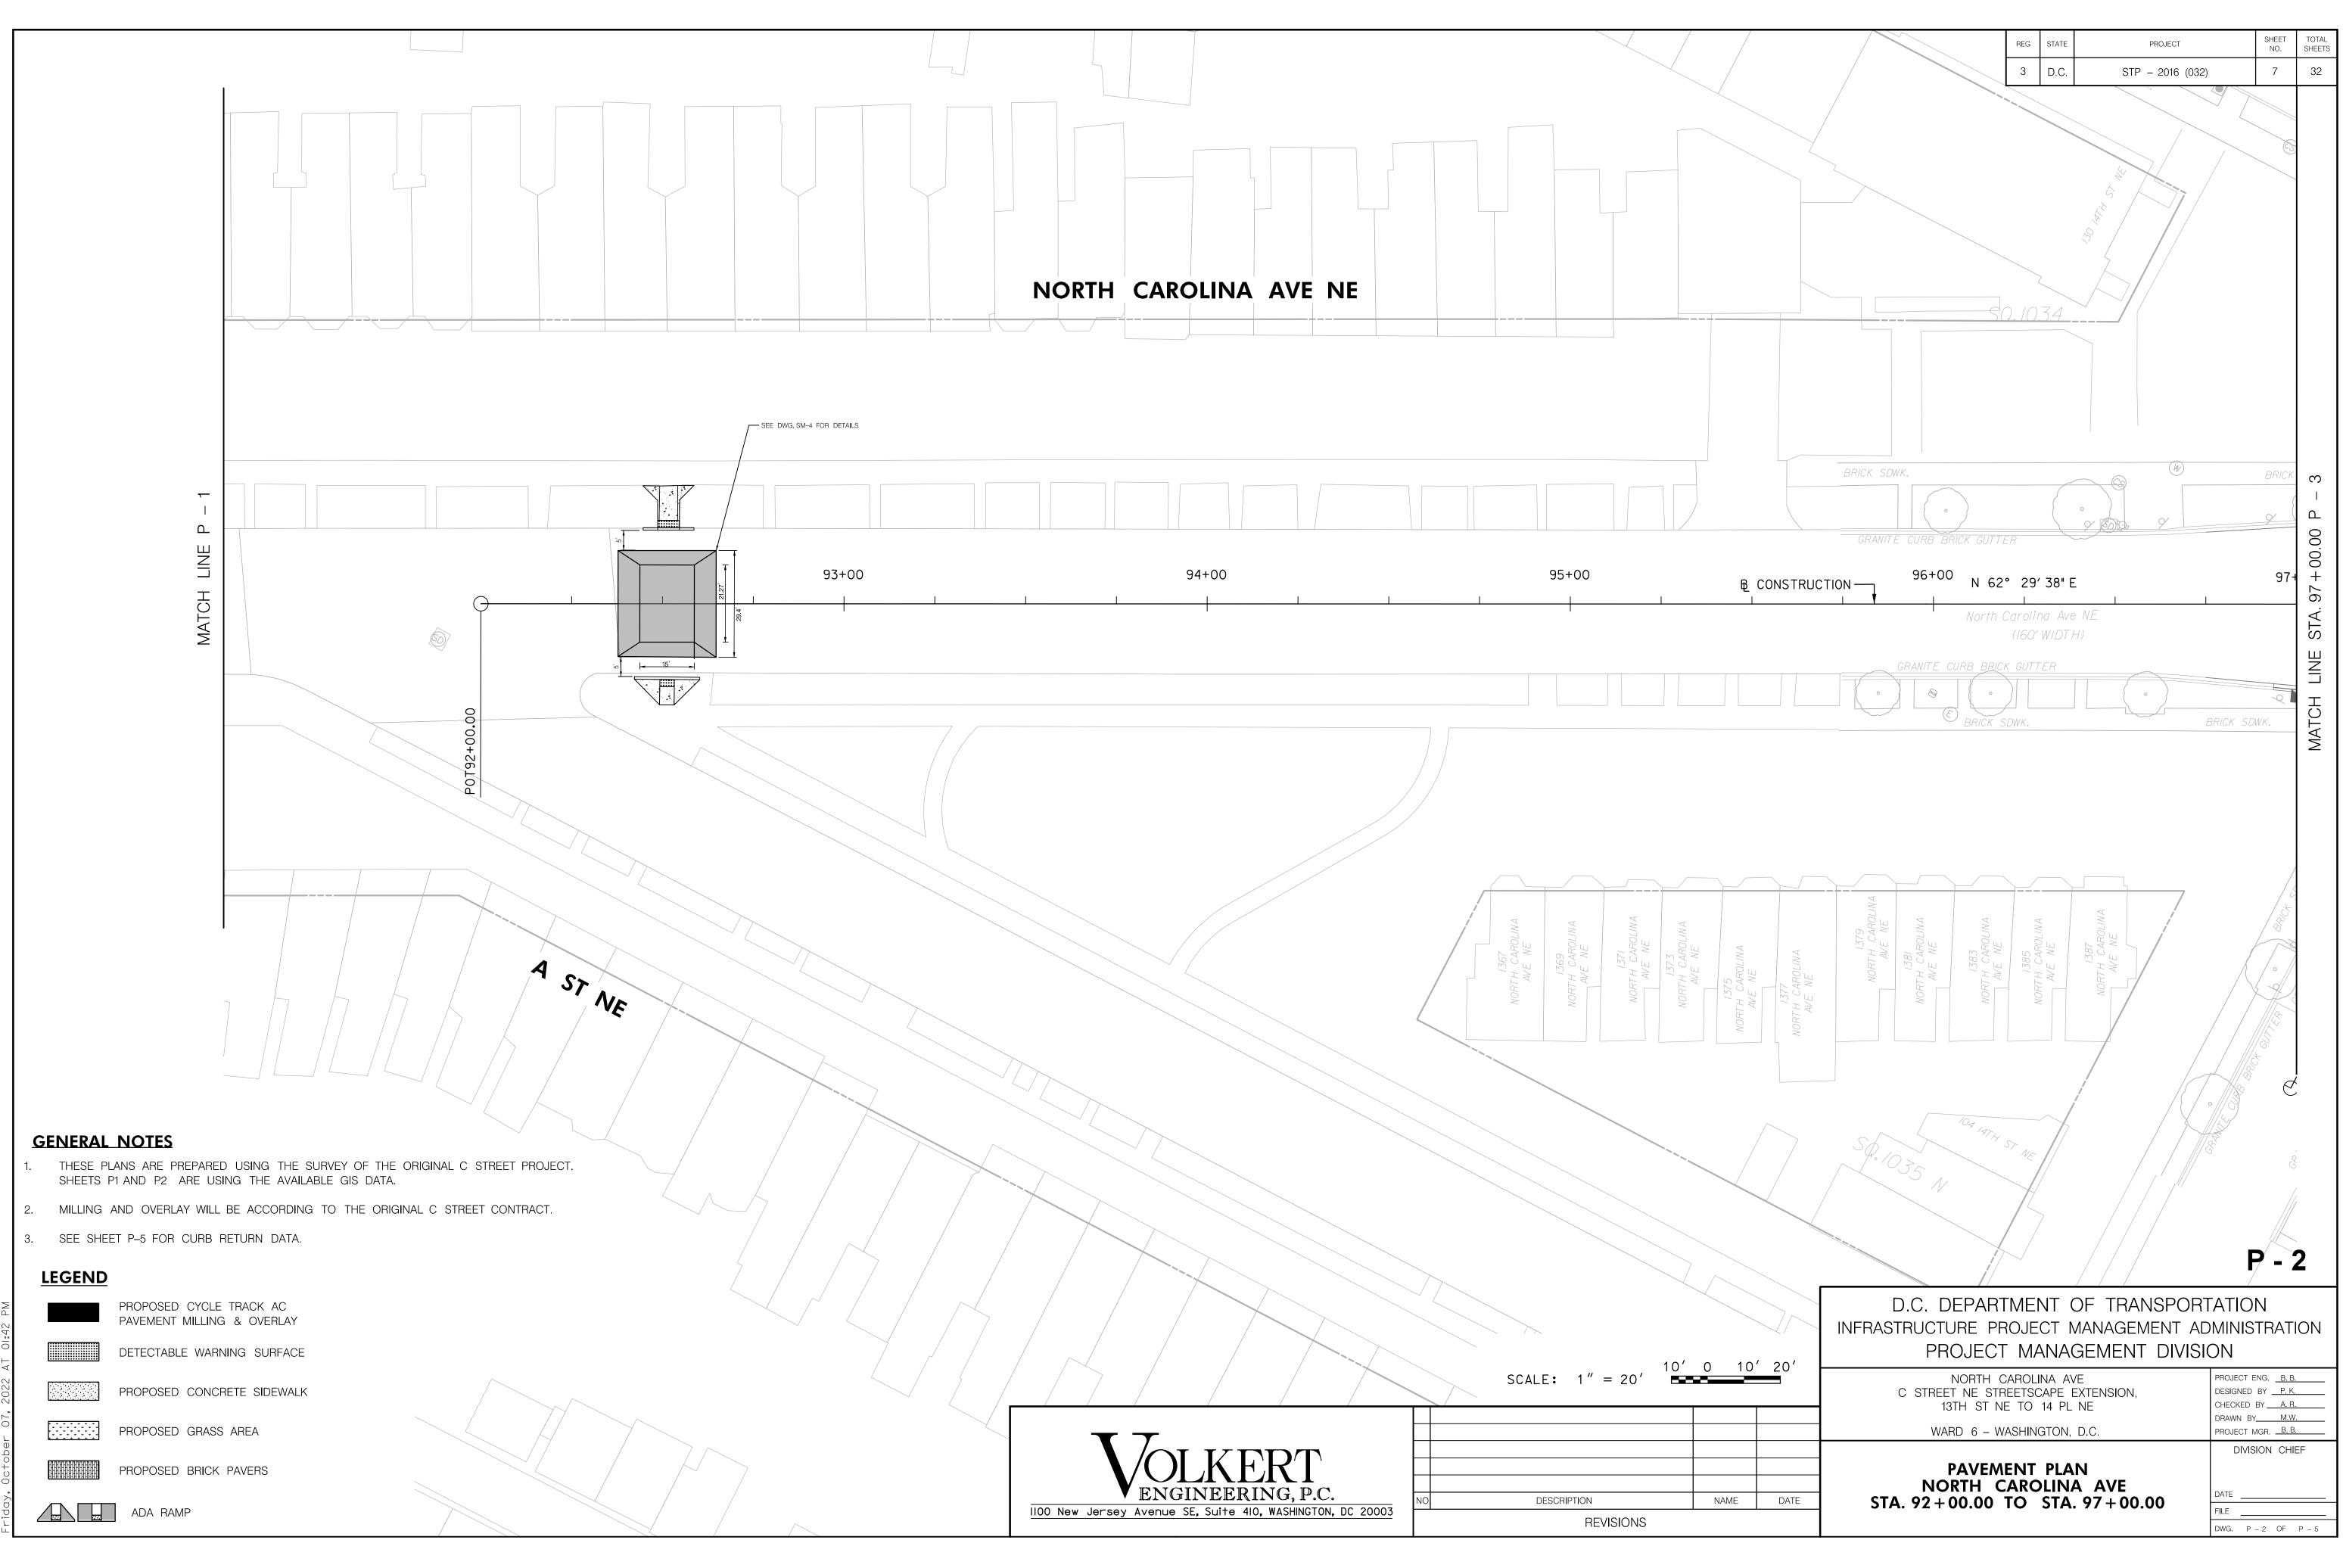
Point 10	Ν	446,290.50 E	1,316,725.69	Sta	10+00.00
Course from 10	to 11 N 0° 00	′ 50.75″ W Dist ′	150.00		
Faustion: Sta 1		- Sta 12100 00 ()	A11.5	End	Region 1
		= Sta 12+00.00 (/	чп /	Begir	n Region 2
Point 11	N	446,440.50 E	1,316,725,66	Sta	12+00.00

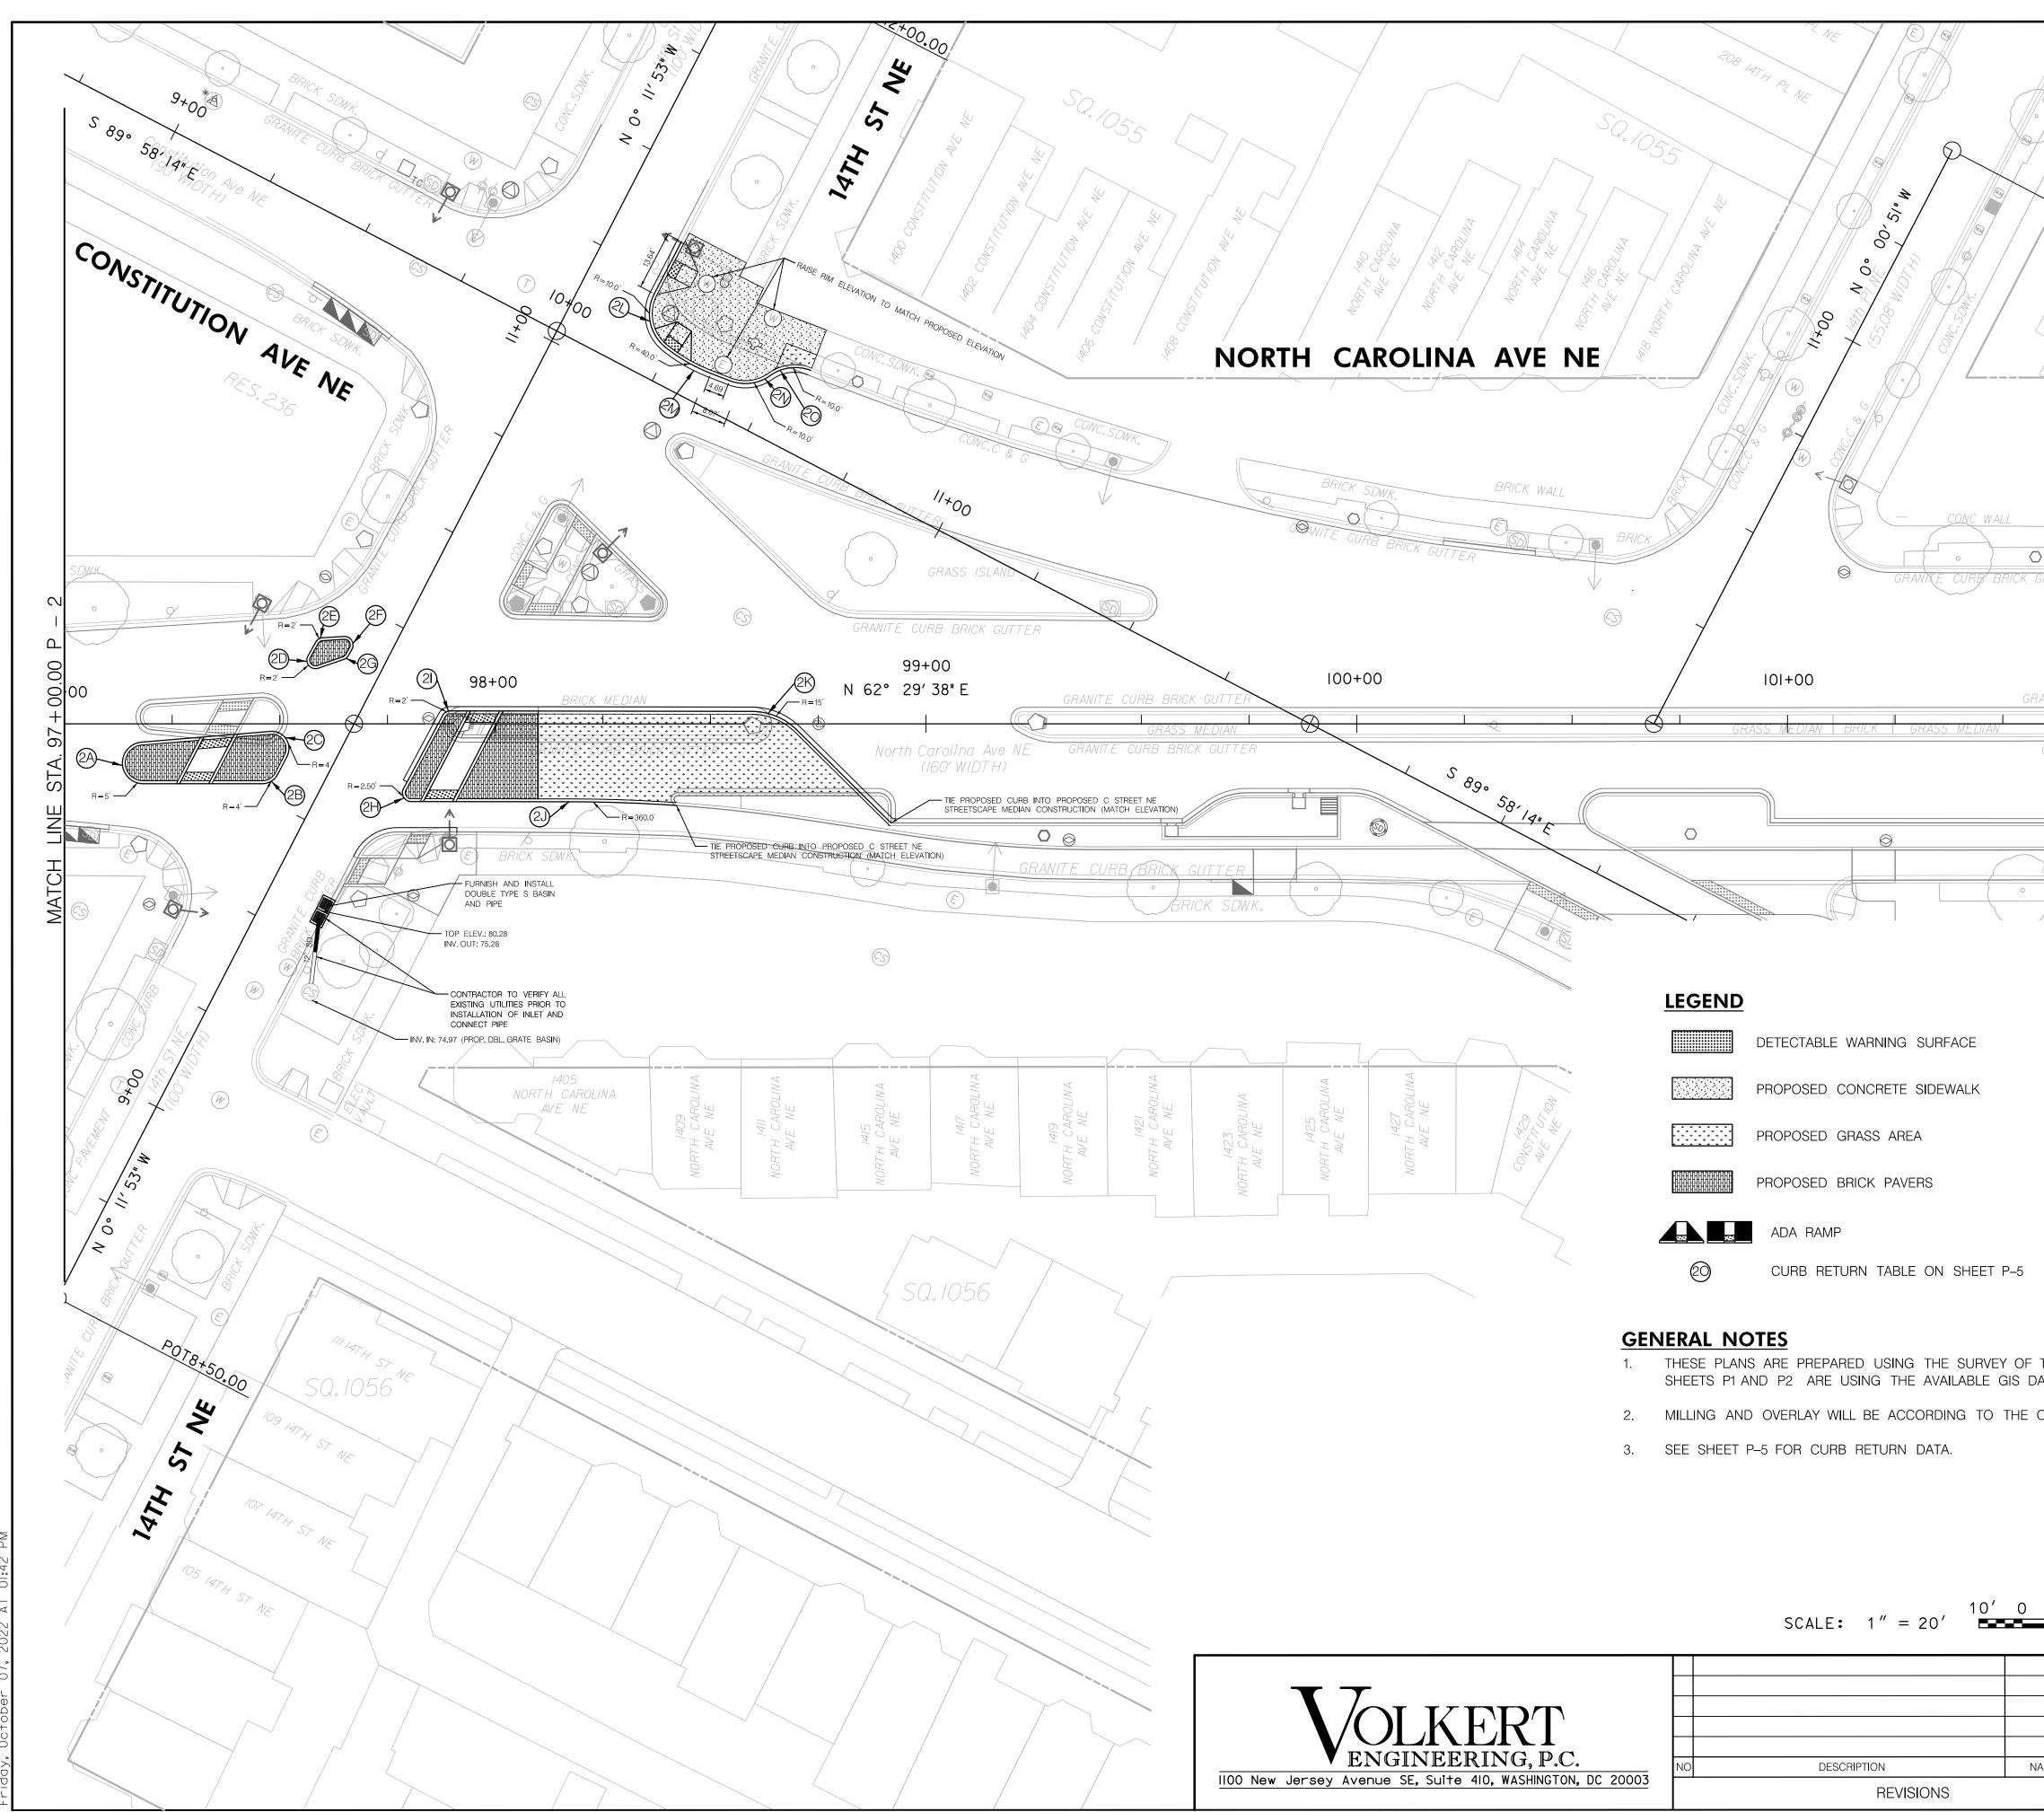


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				D.C. DEPARTMENT OF TRANSPORTATION INFRASTRUCTURE PROJECT MANAGEMENT ADMINISTRATION PROJECT MANAGEMENT DIVISION			
				NORTH CAROLINA AVE C STREET NE STREETSCAPE EXTENSION, 13TH ST NE TO 14 PL NE WARD 6 – WASHINGTON, D.C.	PROJECT ENG. B. B. DESIGNED BY P. K. CHECKED BY A. R. DRAWN BY M. W. PROJECT MGR. B. B.		
	IO DESCRIPTION	NAME	DATE	HORIZONTAL ALIGNMENT DATA	DIVISION CHIEF		
REVISIONS					FILE		

REG	STATE	PROJECT	SHEET NO.	TOTAL SHEETS
3	D.C.	STP – 2016 (032)	5	32



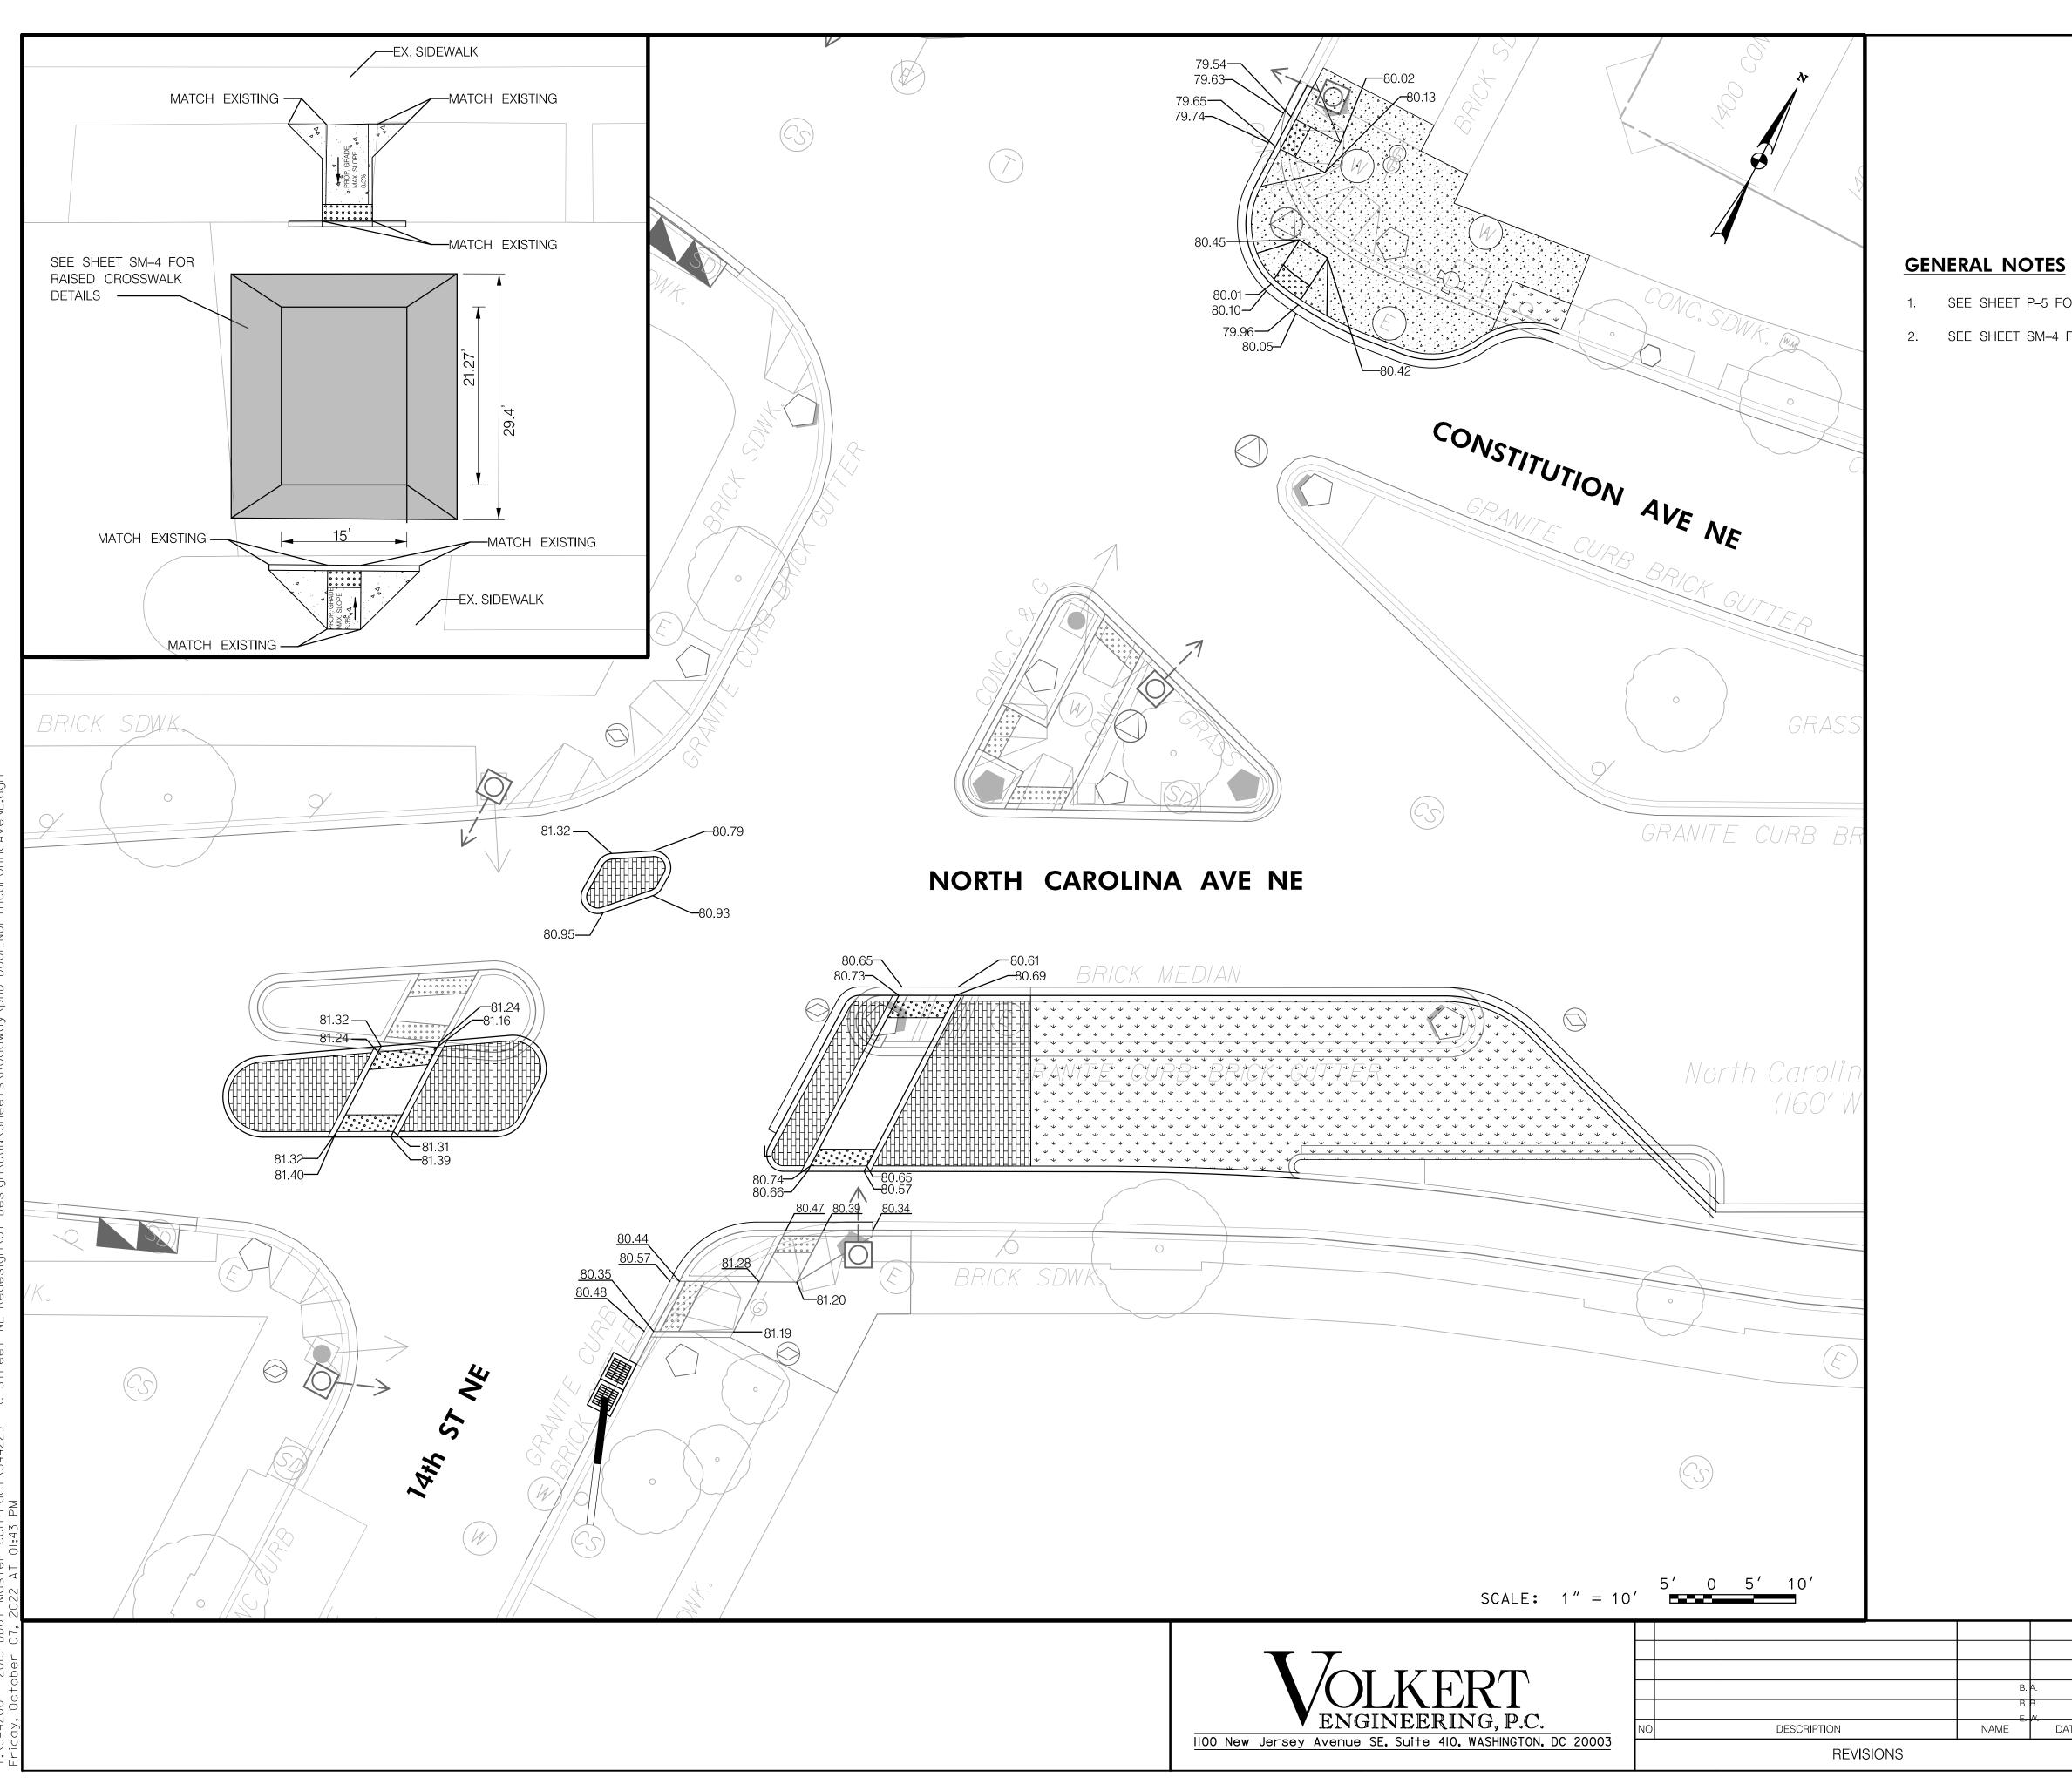




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	NORTH C C STREET NE STR			XTENSION, DESIGNED	ENG. <u>B.B</u> BY <u>P.K</u>	<u>. </u>
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REG	STATE	PROJECT	SHEET NO.	TOTAL SHEETS
3	D.C.	STP – 2016 (032)	9	32

1. SEE SHEET P-5 FOR CURB RETURN DATA.

2. SEE SHEET SM-4 FOR .CURB RAMP STANDARD DETAILS.



	D.C. DEPARTMENT OF TRANSPORT INFRASTRUCTURE PROJECT MANAGEMENT AD PROJECT MANAGEMENT DIVISIO	MINISTRATION
	NORTH CAROLINA AVE C STREET NE STREETSCAPE EXTENSION, 13TH ST NE TO 14 PL NE WARD 6 – WASHINGTON, D.C.	PROJECT ENG. <u>B. B.</u> DESIGNED BY <u>P. K.</u> CHECKED BY <u>B. B.</u> DRAWN BY <u>M. W.</u> PROJECT MGR. <u>B. B.</u>
в. А. в. в. <u>е. </u>	CURB RAMP DETAILS – 1	DIVISION CHIEF
		FILE DWG. P - 4 OF P - 5

				CURB RETU	JRN STA	FION / C	OFFSET	(FACE OF CU	RB)		
CURVE	POINTS	STATION	OFFSET		BASE	LINE		ANGLE	RADIUS (FT.)	LENGTH (FT.)	TANGENT
2A	PC PT	97+17.88 97+18.29	4.27 RT 13.91 RT	North	Carolina	Avenue	NE	175 🛯 2'16"	4.83	14.77	115.34
2B	PC PT	97+45.95 97+49.50	13.90 RT 11.75 RT	North	Carolina	Avenue	NE	62 28'50"	4.00	4.36	2.43
2C	PC PT	97+51.67 97+47.78	7.58 RT 1.75 RT	North	Carolina	Avenue	NE	122 🛿 8'54''	4.00	8.54	7.26
2D	PC PT	97+56.54 97+58.93	15.69 LT 12.91 LT	North	Carolina	Avenue	NE	138 07'15"	2.00	4.82	5.23
2E	PC PT	97+59.94 97+58.31	19.98 LT 18.96 LT	North	Carolina	Avenue	NE	57 [14'04''	2.00	2.00	1.09
2F	PC PT	97+66.75 97+64.88	17.32 LT 20.28 LT	North	Carolina	Avenue	NE	122 38'47"	2.00	4.28	3.66
2G	PC PT	97+64.84 97+65.94	14.93 LT 15.85 LT	North	Carolina	Avenue	NE	4159'54"	2.00	1.47	0.77
2H	PC PT	97+78.69 97+80.45	15.09 RT 18.03 RT	North	Carolina	Avenue	NE	11801'38"	2.00	4.12	3.33
21	PC PT	97+89.57 97+87.81	3.00 LT 1.95 LT	North	Carolina	Avenue	NE	6157'24"	2.00	2.16	1.20
2J	PC PT	98+42.08 98+18.17	18.95 RT 18.11RT	North	Carolina	Avenue	NE	3¤8'27"	360.00	23.92	11.97
2K	PC PT	98+70.06 98+59.55	1.44 RT 2.89 LT	North	Carolina	Avenue	NE	44 [32'38"	15.00	11.66	6.14
2L	PC PT	10+16.09 10+24.18	18.11LT 8.29 LT	Cons	titution	Avenue	NE	79 D1'15"	10.00	13.79	8.25
2M	PC PT	10+24.18 10+36.27	8.29 LT 7.81 LT	Cons	titution	Avenue	NE	17/23'17"	40.00	12.14	6.12
2N	PC PT	10+40.93 10+48.73	8.34 LT 13.74 LT	Cons	titution	Avenue	NE	56 [37'59"	10.00	9.88	5.39
20	PC PT	10+48.73 10+56.52	13.74 LT 19.15 LT	Cons	titution	Avenue	NE	56 [37'59"	10.00	9.88	5.39

GENT	
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		P - 5
		D.C. DEPARTMENT OF TRANSPORTATION INFRASTRUCTURE PROJECT MANAGEMENT ADMINISTRATIO PROJECT MANAGEMENT DIVISION
	SCALE: 1" = 20'	NORTH CAROLINA AVE PROJECT ENG. B. B. C STREET NE STREETSCAPE EXTENSION, DESIGNED BY B. A. 13TH ST NE TO 14 PL NE CHECKED BY B. B.
		WARD 6 – WASHINGTON, D.C. DRAWN BY E.W.
VOLKERT ENGINEERING, P.C.	NO DESCRIPTION NAME REVISIONS	DATE FILE DATE DATEDATE

REG	STATE	PROJECT	SHEET NO.	TOTAL SHEETS
3	D.C.	STP – 2016 (032)	10	32
			-	

GENERAL NOTES:

THE DESIGN AND CONSTRUCTION WORK FOR THIS PROJECT SHALL BE PERFORMED IN ACCORDANCE WITH THE APPLICABLE FEDERAL AND STATE LAWS AND DDOT STANDARDS AND SPECIFICATIONS. SEQUENCE OF CONSTRUCTION/ MAINTENANCE OF TRAFFIC (SOC/MOT) IS INTENDED AS A GUIDE, IT IS NOT TO ENUMERATE EVERY DETAIL WHICH MUST BE CONSIDERED IN THE CONSTRUCTION OF EACH PHASE OR STAGE. BUT ONLY TO SHOW THE GENERAL HANDLING OF EXISTING TRAFFIC. ANY CHANGES TO THE SOC/MOT PLAN MUST BE APPROVED BY THE ENGINEER PRIOR TO ANY CONSTRUCTION THAT MAY AFFECT EXISTING TRAFFIC. UNLESS OTHERWISE APPROVED OR DIRECTED BY THE ENGINEER. THE CONTRACTOR SHALL PLAN AND PROSECUTE THE WORK IN ACCORDANCE WITH THE FOLLOWING:

- I. THE CONTRACTOR IS REQUIRED TO FOLLOW THE MAINTENANCE OF TRAFFIC (M.O.T.) REQUIREMENTS SET FORTH IN THIS PLAN, THE 2009 MANUAL ON UNIFORM TRAFFIC CONTROL DEVICES (MUTCD). 2013 DDOT STANDARD AND SPECIFICATIONS AND THE 2006 D.C TEMPORARY TRAFFIC CONTROL MANUAL. IN ADDITION. THE CONTRACTOR SHALL FOLLOW SECTIONS 104.02 AND 612 OF THE DDOT SPECIFICATIONS FOR IMPLEMENTATION MAINTENANCE OF TRAFFIC PLANS. THE MOT PLANS INCLUDED ARE SUGGESTED: THE CONTRACTOR WILL BE REQUIRED TO SUPPLEMENT THE MOT PLANS AS NECESSARY FOR CONDITIONS NOT SHOWN IN THE MOT PLANS SUCH AS THE INSTALLATION OF UNDERGROUND UTILITIES. TRAFFIC LANE SHIFTS. AND FOR ANY OTHER SPECIFIC CONDITION BEYOND THE GENERAL SEQUENCE PRESENTED IN THE MOT PLAN SET. PAYMENT FOR PREPARATION OF THE ADDITIONAL MOT PLANS WILL BE MADE AS SPECIFIED IN 612.02(C) OF THE STANDARD SPECIFICATIONS.
- 2. NORTH CAROLINA AVE. NE AND 13TH STREET. NE ARE COLLECTOR STREETS WHICH RUN IN EAST-WEST AND NORTH-SOUTH DIRECTIONS. RESPECTIVELY, BOTH OF THESE STREETS INTERSECT WITH SEVERAL SIDE STREETS AND DRIVEWAYS WITHIN THE PROJECT LIMITS AS IDENTIFIED ON THE PLANS.
- 3. ALL ADVANCE CONSTRUCTION WARNING SIGNING SHALL BE INSTALLED PRIOR TO THE BEGINNING OF EACH PHASE OF CONSTRUCTION.
- 4. METRO BUS STOPS LOCATED ALONG NORTH CAROLINA AVE. NE AND 14TH STREET. NE ARE TO BE MAINTAINED THROUGHOUT CONSTRUCTION. BUS STOPS IMPACTED DURING CONSTRUCTION ACTIVITIES SHALL BE RELOCATED TO THE UPSTREAM OR DOWNSTREAM BLOCK AND REQUIRE PRIOR APPROVAL. CONTRACTOR SHALL COORDINATE WITH WMATA AND DDOT.
- 5. THE CONTRACTOR SHALL PLACE APPROPRIATE SIGNING TO DIRECT PEDESTRIANS WITHIN AND ADJACENT TO THE PROJECT LIMITS.
- 6. THE CONTRACTOR SHALL COVER EXISTING SIGNS THAT CONFLICT WITH THE PROPOSED MOT PLANS.
- 7. APPROVED CHANNELIZING DEVICES MUST SEPARATE THE WORK AREA FROM THE TRAVEL WAY AND BE EXTENDED TO WHERE THEY ARE VISIBLE TO ONCOMING TRAFFIC.
- 8. ALL CRACKS SHALL BE CLEANED OF DEBRIS AFTER MILLING AND SEALED WITH CRACK SEALANT IN ACCORDANCE WITH THE DDOT SPECIFICATIONS SECTION 807.02 FOR JOINT SEALING MATERIALS.
- 9. THE CONTRACTOR IS RESPONSIBLE FOR REPLACEMENT OF ANY EXISTING PAVEMENT MARKINGS AND SIGNS WHICH ARE NOT SCHEDULED FOR REPLACEMENT BUT BECOME DAMAGED BY CONSTRUCTION. THIS IS CONSIDERED INCIDENTAL TO OTHER WORK. PAVING DURING CONSTRUCTION PHASES SHALL BE CARRIED THROUGH BINDER COURSE. REMOVAL OF EXISTING PAVEMENT MARKINGS SHALL BE COMPLETED ACCORDING TO SECTION 612.03 OF THE DDOT SPECIFICATIONS. FINAL SURFACE COURSE SHALL BE PLACED ONCE ALL PHASES OF CONSTRUCTION ARE COMPLETE.

- DISRUPTION OF TRAFFIC.
- SECTION 505.04, DDOT SPECIFICATIONS.
- COMPLETION OF THE PROJECT.
- SIGN.

- SHOWN ON PLANS.
- NOT IN USE.
- AT ALL TIMES.

IO. TEMPORARY CONNECTIONS AND PHASED CONSTRUCTION SHALL BE CONSTRUCTED AND COMPLETED IN A MANNER THAT WILL MINIMIZE

II. THE CONTRACTOR SHALL NOT LEAVE ANY PORTION OF THE WORK ZONE WITH ANY OPEN TRENCHES UNATTENDED WHERE BARRIER IS NOT PRESENT. ON AREAS WHERE BARRIER IS NOT PRESENT THE CONTRACTOR SHALL NOT MAKE PAVEMENT EXCAVATIONS OR OPENINGS TO A GREATER EXTENT THAT CAN BE REPLACED AND REPAVED DURING THE SAME WORKING DAY, UNLESS OTHERWISE APPROVED BY THE ENGINEER PER

12. ALL DETOUR SIGNS USED DURING STREET CLOSURES SHALL BE COVERED OR REMOVED WHEN NOT IN USE.

13. THE CONTRACTOR SHALL MAINTAIN ALL SIGNAGE WITHIN THE LIMITS OF CONSTRUCTION. SHOWN OR OTHERWISE. UNLESS DIRECTED BY THE ENGINEER. IF REMOVAL IS ALLOWED. CONTRACTOR SHALL STORE THE SIGNS PER DDOT STANDARDS. AND IF DIRECTED, REPLACE THEM AT THE

14. THE CONTRACTOR SHALL SUBMIT MESSAGES FOR ANY PORTABLE CHANGEABLE MESSAGE SIGNS (PCMS) FOR REVIEW AND APPROVAL PRIOR TO THE START OF CONSTRUCTION. MESSAGES INDICATING AN UPCOMING CHANGE IN TRAFFIC PATTERN MUST BE DISPLAYED ONE (I) WEEK PRIOR TO THE CHANGE IN TRAFFIC PATTERN. PCMS SIGNS MUST BE ON-SITE ONE (I) WEEK PRIOR TO START OF MOT WORK AND MUST REMAIN ON-SITE THROUGH THE DURATION OF THE MOT WORK IDENTIFIED ON THE

15. THE CONTRACTOR IS REQUIRED TO NOTIFY FIRE. POLICE AND EMERGENCY SERVICES DEPARTMENTS OF APPROVED ROAD CLOSURES. PERMITS WITH THEIR APPROVAL MUST BE ON-SITE WITH ALL OTHER PERMITS PER DDOT TOA. TCP INSPECTION CRITERIA. 11TH EDITION. OCTOBER 2010.

16. ALL SIGNS (BOTH PERMANENT AND CONSTRUCTION) SHALL HAVE PRISMATIC LENS TYPE RETRO-REFLECTIVE SHEETING. THIS IS CONSIDERED INCIDENTAL TO OTHER WORK. CONSTRUCTION SIGNS ARE TO BE FURNISHED BY THE CONTRACTOR AND ERECTED AND MAINTAINED BY THE CONTRACTOR IN ACCORDANCE WITH SECTION 612 OF THE SPECIFICATIONS. ALL WARNING SIGNS AND TEMPORARY TRAFFIC CONTROL DEVICES SHALL BE PROMPTLY REMOVED AT THE COMPLETION OF WORK AND DISCARDED AS DIRECTED BY THE ENGINEER.

17. SIDEWALK ACCESS FOR RESIDENTS ALONG NORTH CAROLINA AVE. NE. 13TH STREET. NE. AND 14TH STREET. NE SHALL BE MAINTAINED BY THE CONTRACTOR AT ALL TIMES DURING CONSTRUCTION.

18. THE CONTRACTOR SHALL CONTACT DDOT ENGINEER A MINIMUM OF SEVEN (7) DAYS IN ADVANCE FOR ALL PARKING SPACES WITHIN THE WORK ZONE WHICH REQUIRE TEMPORARY REMOVAL AS PART OF THE MOT PHASES

19. PARKING SIGNS OF IMPACTED PARKING SHALL BE TEMPORARILY COVERED BY THE CONTRACTOR FOR THE DURATION OF WORK AND REMOVED WHEN

20. THE CONTRACTOR SHALL PLAN AND ERADICATE EXISTING CROSSWALK LINES AND PROVIDE TEMPORARY PAVEMENT MARKING LINES TO CONNECT BETWEEN EXISTING AND PROPOSED RAMPS. OR BETWEEN PROPOSED RAMPS DURING EACH MOT PHASE. AND MAINTAIN PEDESTRIAN ACCESS

21. THE CONTRACTOR SHALL PROTECT ALL EXISTING TREES TO REMAIN PRIOR TO START OF ANY CONSTRUCTION WORK AND SHALL REMOVE THE TREE PROTECTIONS UPON COMPLETION OF ALL CONSTRUCTION WORK ONLY.

22. THE CONTRACTOR MUST COMPLY WITH PEDESTRIAN SAFETY REQUIREMENT IDENTIFIED IN DDOT STANDARD SPECIFICATIONS 104.02C(3)

SEQUENCE OF CONSTRUCTION

THE PROJECT GENERALLY COMPRISES OF THREE PHASES OF WORK. ALL PHASES WILL HAVE SIMILAR MOT SETUPS. THE FIRST PHASE WILL INVOL CONSTRUCTION OF RAISED CENTER MEDIANS, ADA RAMPS AND NORTHERN OF RAISED CROSSWALK ON NORTH CAROLINA AVENUE, NE, AND THE BUL CONSTITUTION AVENUE, NE, WHILE THE SECOND PHASE WILL CONSTRUCT GRATE INLET AND STORM DRAIN SYSTEM PIPE AT SE QUADRANT OF NO CAROLINA AVE. NE AND 14TH ST. NE INTERSECTION. AND THE REMAINING SOUTHERN PORTION OF RAISED CROSSWALK ON NORTH CAROLINA, AVE, I OF A ST, NE. DURING PHASE THREE, ASSOCIATED TRAFFIC SIGNALS MODI WORK FOR 14TH ST. NE/NORTH CAROLINA AVE, NE/CONSTITUTION AVE, I 13TH ST, NE/NORTH CAROLINA AVE, NE/EAST CAPITOL ST, NE INTERSEC MILLING AND PAVING OPERATIONS, AND FINAL PAVEMENT MARKING AND INSTALLATION WITHIN THE PROJECT LIMIT WILL BE PERFORMED. DURING CONSTRUCTION THE CONTRACTOR SHALL ENSURE THE FOLLOWING:

-MAINTAIN BICYCLE AND PEDESTRIAN TRAFFIC AT ALL TIMES.

-THE CONTRACTOR SHALL KEEP OPEN THREE OR MORE CROSSWALKS FO INTERSECTION AT A TIME.

-ACCESS TO SIDEWALKS SHALL BE MAINTAINED AT ALL TIMES.

-DUE TO PARKING LIMITATIONS. CONTRACTOR SHALL MINIMIZE THE NUMBE RESTRICTED PARKING ALONG NORTH CAROLINA AVE. NE BETWEEN 13TH S AND 14TH ST. NE.

-THE MINIMUM TRAVEL LANE SHALL BE II FEET.

-NEWLY STRIPED BIKE LANES ALONG NORTH CAROLINA AVE. NE BETWEEN NE AND 14TH ST. NE SHALL ONLY BE OPENED AFTER THE COMPLETION CONSTRUCTION WITH APPROVALS OF THE DDOT ENGINEER.

TIME OF DAY	HOUR	NOTE
WEEKDAY AM PEAK	5:30 AM - 9:30 AM	RESTRICTION
WEEKDAY PM PEAK	3:30 PM - 7:00 PM	RESTRICTION
WEEKDAY OFF-PEAK (MID-DAY)	9:30 AM - 3:30 PM	
NIGHT TIME	9:30 PM - 5:30 AM	
WEEKEND (SAT & SUN)	7:00 AM - 7:00 PM	

NOTES:

I. NO ADDITIONAL LANE CLOSURES OR FLAGGING OPERATIONS SHALL BE ADDED TO THE LONG-TERM MOT CONFIGURATION SHOWN FOR PHASE ONE THROUGH PHASE THREE DURING WEEKDAY AM AND PM PEAK HOURS.

2. WEEKEND WORK ARE PERMITTED WITH WRITTEN APPROVAL OF THE CHIEF ENGINEER OR HIS DESIGNEE.



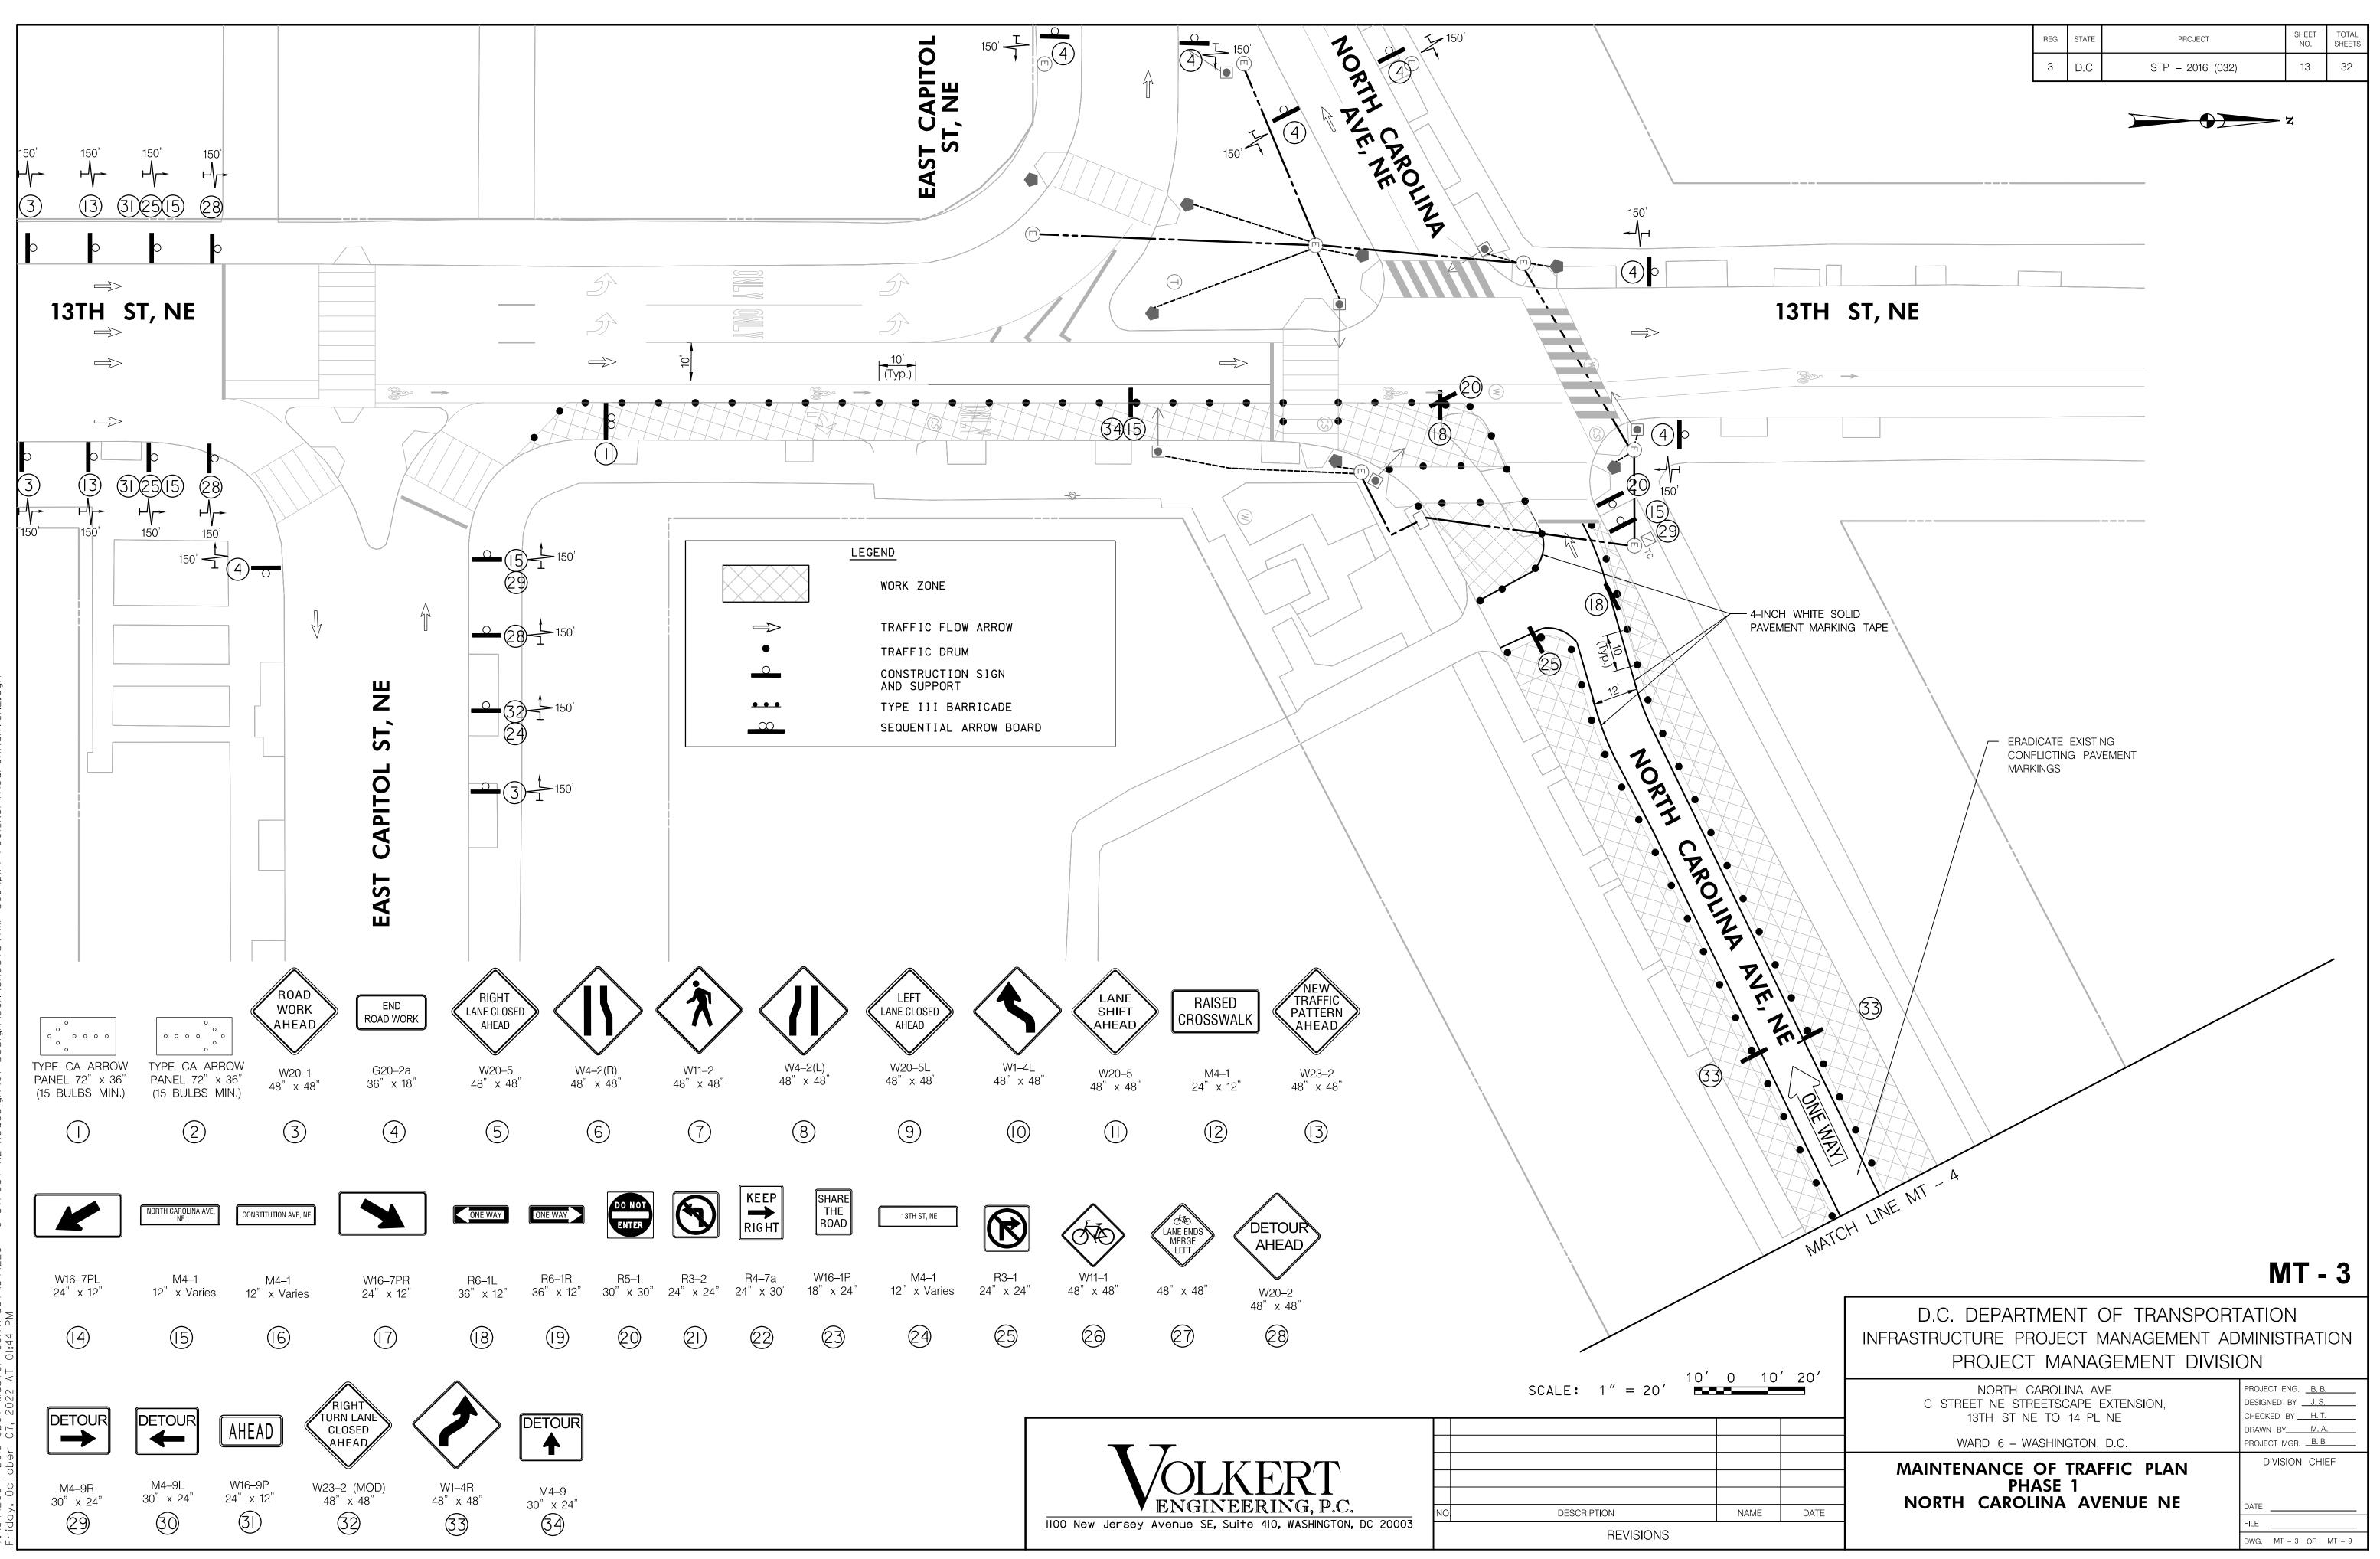
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				D.C. DEPARTMENT OF TRANSPOR INFRASTRUCTURE PROJECT MANAGEMENT AD PROJECT MANAGEMENT DIVISI	DMINISTRATION
				NORTH CAROLINA AVE C STREET NE STREETSCAPE EXTENSION, 13TH ST NE TO 14 PL NE WARD 6 – WASHINGTON, D.C.	PROJECT ENG. <u>B. B.</u> DESIGNED BY J. S. CHECKED BY <u>H. T.</u> DRAWN BY <u>M. A.</u> PROJECT MGR. <u>B. B.</u>
NO.	DESCRIPTION	NAME	DATE	MAINTENANCE OF TRAFFIC GENERAL NOTES AND SEQUENCE OF CONSTRUCTION	DIVISION CHIEF DATE FILE DWG, MT = 1 OF MT = 9

		REG	STATE	PROJECT	SHEET NO.	TOTAL SHEETS
		3	D.C.	STP – 2016 (032)	11	32
E	PRE-PHASE PRIOR TO STARTING THE W MOT CONFIGURATIONS AS S CONFIGURATIONS WILL INVO BETWEEN 13TH ST, NE AND	SHOWN	N PLA SETTI	NS. THESE LONG-TERM N NG NORTH CAROLINA AVI	MOT E, NE	
THREE	AND PERMANENTLY CLOSE LANE BETWEEN EAST CAPI UNTIL PROJECT COMPLETIO CONTROL SIGNS AND PAVE SHALL BE PROVIDED PRIOR	THE TOL S N. AL MENT	EXIST ST, N L AS MAR	FING NB I3TH ST, NE RIG E AND NORTH CAROLINA SOCIATED TEMPORARY TI KINGS AS WELL AS PCMS	HT-TUR AVE, N RAFFIC S UNITS	RN IE
VE N PORTION B-OUT ON THE ORTH S NE NORTH IFICATION NE, AND CTIONS, SIGNING	PHASE I WORK IN PHASE I CONSISTS MEDIANS FOR EAST AND W CAROLINA AVE, NE INTERSE CROSSWALK AND ADA RAM OF A ST, NE, AND BULB-O AND CONSTITUTION AVENUE OF CLOSING THE I3TH ST, ST, NE AND NORTH CAROLI OPEN.	EST ECTIO PS OI UT A , NE NE F	LEGS N, AN N NOF T TH INTEI RIGHT-	OF 14TH ST, NE AND NO D NORTHERN PORTION OF RTH CAROLINA AVENUE, N E NE QUADRANT OF 14TH RSECTION. THE WORK ALS TURN LANE BETWEEN EA	ORTH F RAISE NE, NOR H ST, N GO CONS AST CA	D TH IE SISTS PITOL
R EACH	PHASE 2 WORK IN PHASE 2 IS SIMILI INCLUDE THE GRATE INLET QUADRANT OF 14TH ST, NE REQUIRE THE 14TH ST, NE TO THE WEST SOUTH OF M ALSO INVOLVE CONSTRUCT THE RAISED CROSSWALK NO NORTH CAROLINA AVE, NE	AND AND ONE- NORTH ING T ORTH	STO NOR WAY CAF HE R OF A	RM DRAIN SYSTEM PIPE TH CAROLINA AVE, NE W TRAFFIC AND BICYCLISTS ROLINA AVE, NE. THIS PHA EMAINING SOUTHERN POR A ST, NE BY SHIFTING TH	AT SE HICH 5 TO SI ASE WIL TION OF HE WB	HIFT L
ER OF ST, NE	PHASE 3 WORK IN PHASE 3 WILL UT IN PHASE ONE OR TWO TO WORK FOR 14TH ST, NE/NO NE, AND 13TH ST, NE/NOR	PER DRTH TH C4	FORM CARO AROLII	THE TRAFFIC SIGNALS I LINA AVE, NE/CONSTITU ⁻	MODIFIC. TION AV OL ST,	ATION 'E, NE

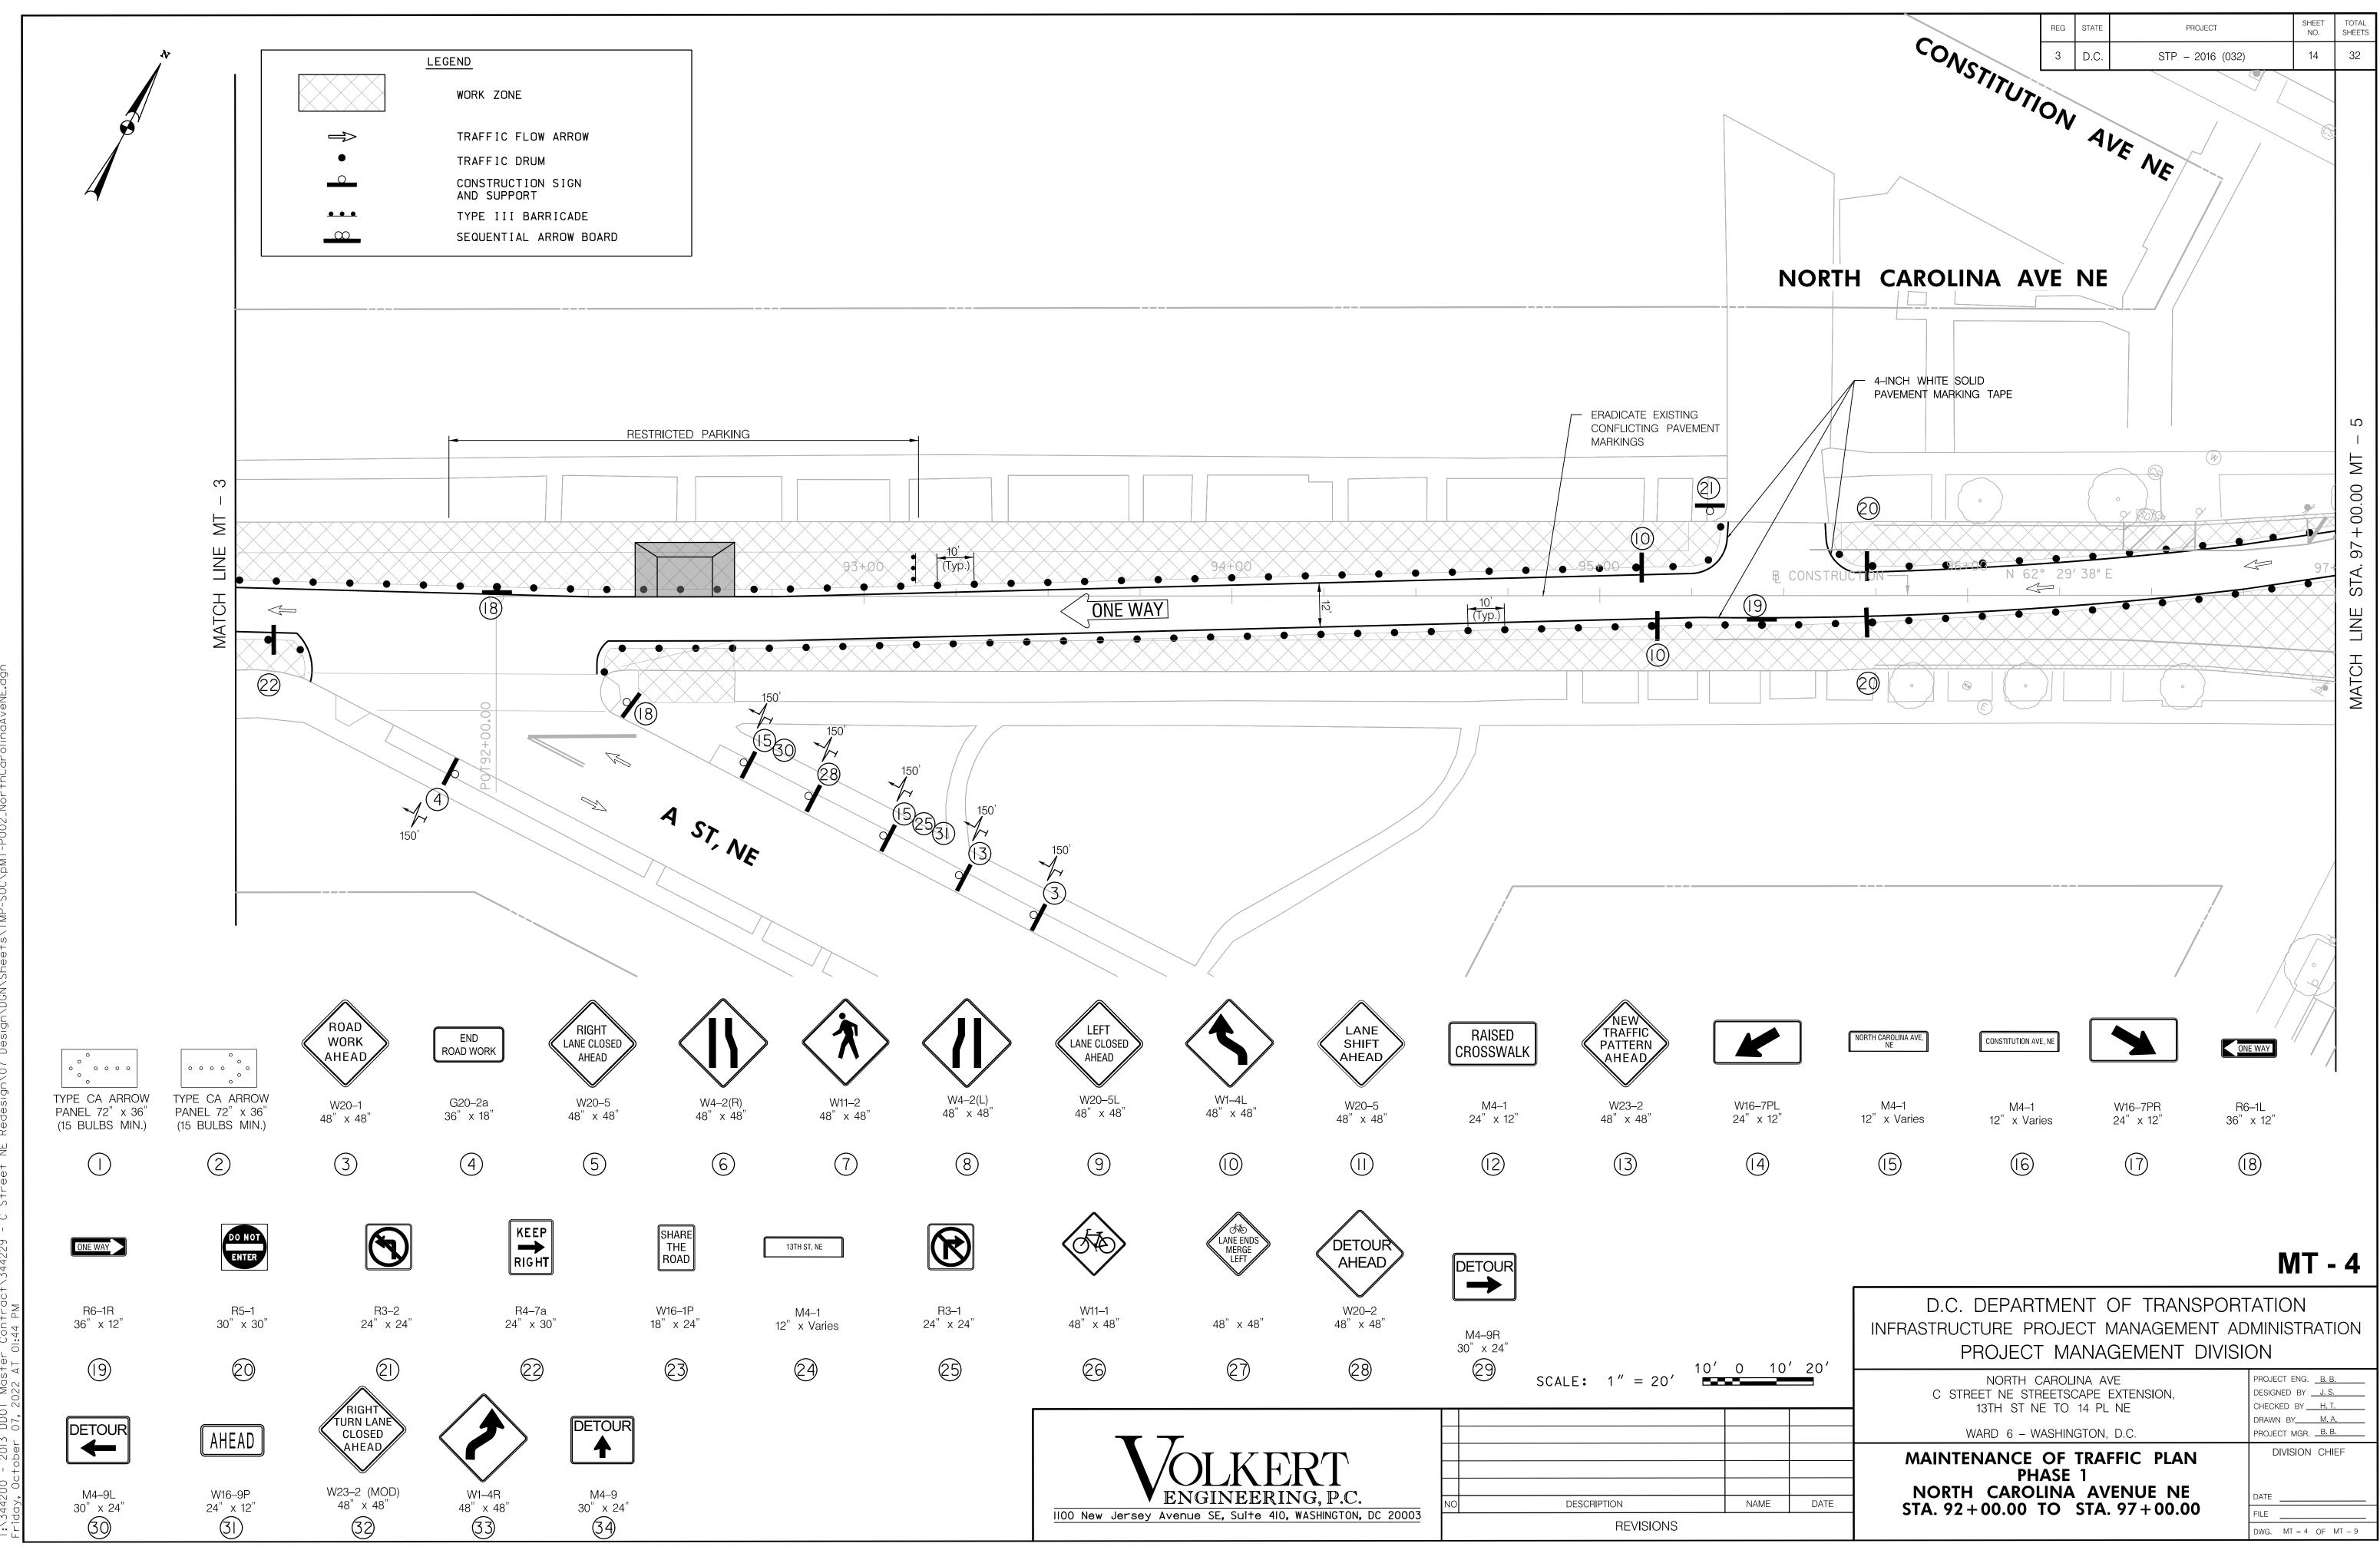
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														3 D.C.	STP – 2016 (032)	12
PAY ITEM NUMBER	612005	612006	612008	612010	612014	612018	612022	612028	612034	612100	612112	612997	612997	612997		
DRAWING	PEDESTRIAN SAFETY BARRICADE	CONSTRUCTION LANE CLOSING	REMOVE LANE MARKINGS	TEMPORARY CONSTRUCTION SIGN SUPPORTS	CONSTRUCTION WARNING AND DETOUR SIGNS	FLASHING AMBER WARNING LIGHTS, TYPE "B"	SEQUENTIAL ARROW BOARDS	TYPE III PVC BARRICADE	TRAFFIC DRUMS	PORTABLE CHANGEABLE MESSAGE SIGN	PREFORMED PAVEMENT MARKINGS, SYMBOLS AND LETTERS	TRAFFIC CONTROL SPECIAL ITEM - LF - PAVEMENT MARKING TAPE, 24 INCH	TRAFFIC CONTROL SPECIAL ITEM - LF - 'PAVEMENT MARKING TAPE, 6 INCH	TRAFFIC CONTROL SPECIAL ITEM - LF - 'PAVEMENT MARKING TAPE, 4 INCH		
	LF	LS	SF	EA	SF	EA	EA	EA	EA	EA	LF	LF	LF	LF		
MT-3 (PHASE 1)	50		169	28	275		1		82	1				432		
MT-4 (PHASE 1)			433	15	132	1		1	106	1				1152		
MT-5 (PHASE 1)			898	31	457	3	1	6	109	1	86			77		
MT-6 (PHASE 2)	50			27			1		77	1				325		
MT-7 (PHASE 2)				16	72	1		1	106	1				940		
MT-8 (PHASE 2)				27	80	2	2	2	81	1	86	51	29	61		
MT-9 (DETOUR)				4	32											
PHASE 3 (NOT SHOWN)	50			12	192				264	3						
AXIMUM NEEDED FOR PHASE 1	50			74		4	2	7	297	3						
MAXIMUM NEEDED FOR PHASE 2	50			70		3	3	3	264	3						
MAXIMUM NEEDED FOR PHASE 3	50			12					264	3						
OST NEEDED AMONG ALL PHASES	50			74		4	3	7	297	3						
		ı	·			·	·			·]		·	·			
TOTAL		1	1500		1240						171	51	29	2988		
TOTAL X UNIT	50			74		4	3	7	297	3						
CONTINGENCY	10		150	6	60	1	1	3	33	1	19	9	6	142		
Total (Not Rounded)	60	1	1650	80	1300	5	4	10	330	4	190	60	35	3130		
TOTAL	60	1	1700	80	1340	5	4	10	350	4	200	60	40	3200		

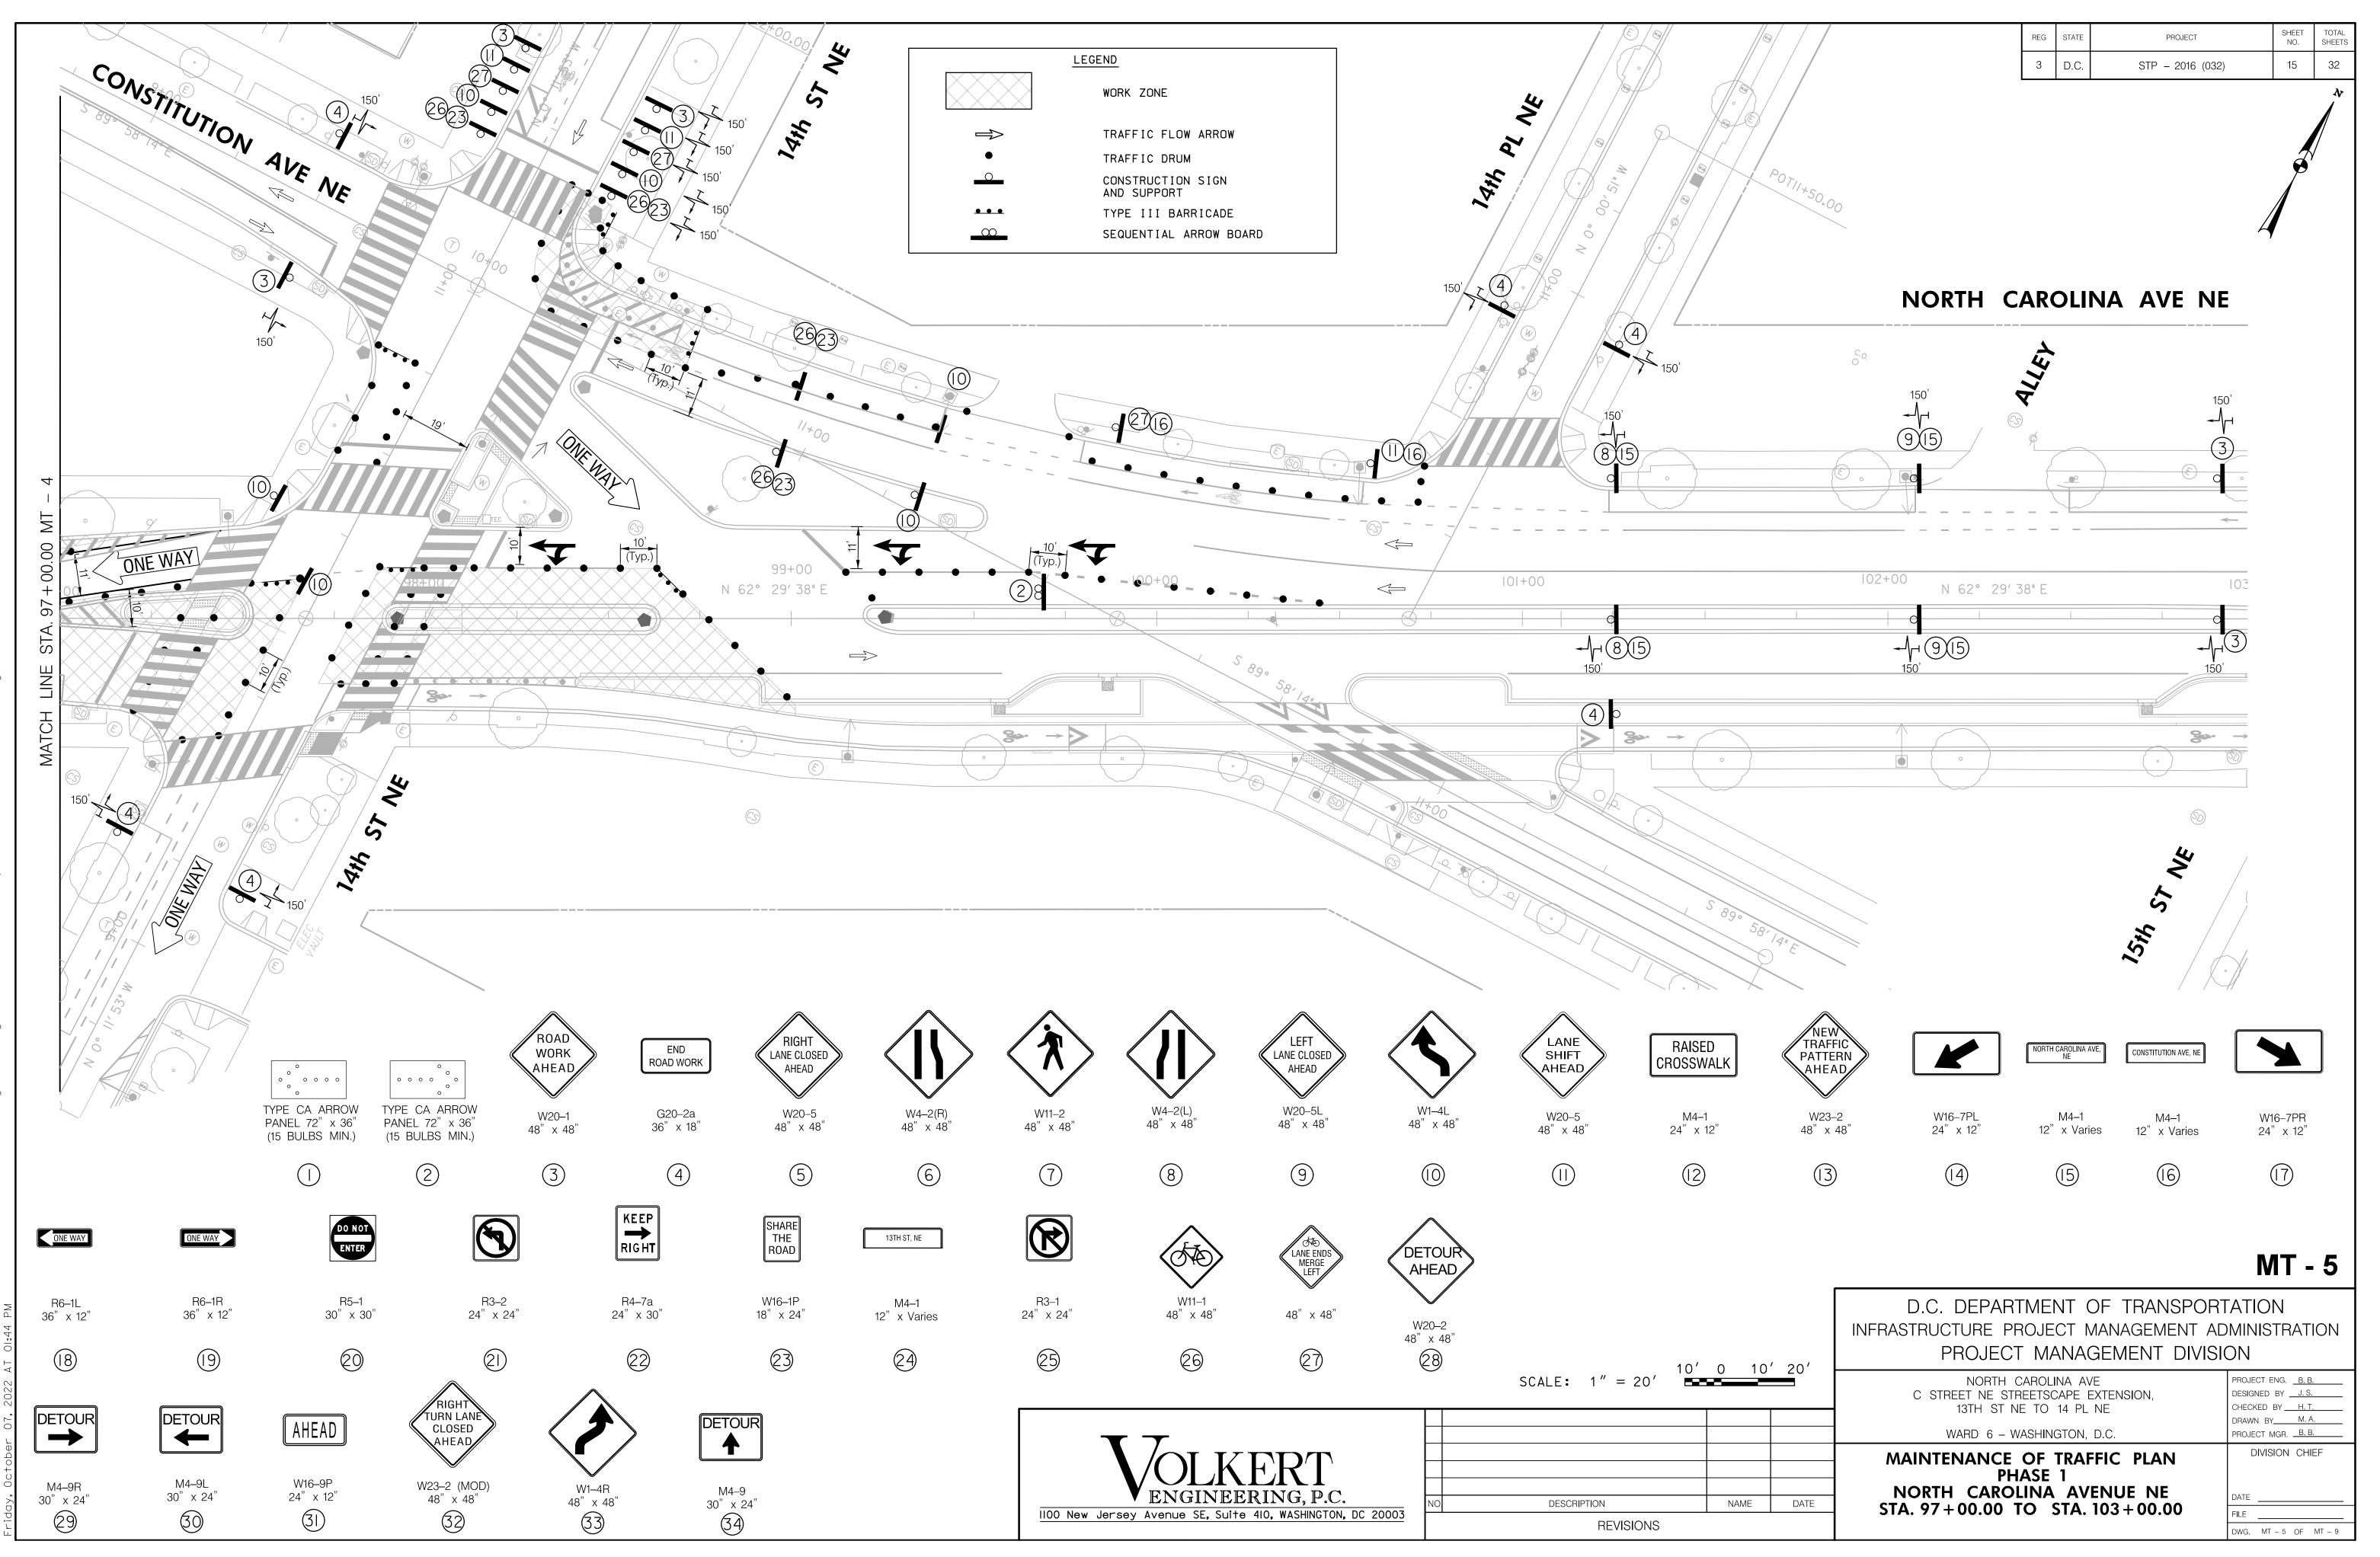
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II00 New Jersey Avenue SE, Suite 410, WASHINGTON, DC 20003	NO.	DESCRIPTION	NAME	DATE	MAINTENANCE OF TRAFFIC QUANTITIES	DIVISION CHIEF
					13TH ST NE TO 14 PL NE WARD 6 – WASHINGTON, D.C.	DRAWN BY <u>M. A.</u> PROJECT MGR. <u>B. B.</u>
					NORTH CAROLINA AVE C STREET NE STREETSCAPE EXTENSION, 12TH ST NE TO 14 DE NE	PROJECT ENG. <u>B. B.</u> DESIGNED BY <u>J. S.</u> CHECKED BY <u>H. T.</u>
					INFRASTRUCTURE PROJECT MANAGEMEN PROJECT MANAGEMENT DI	T ADMINISTRATION
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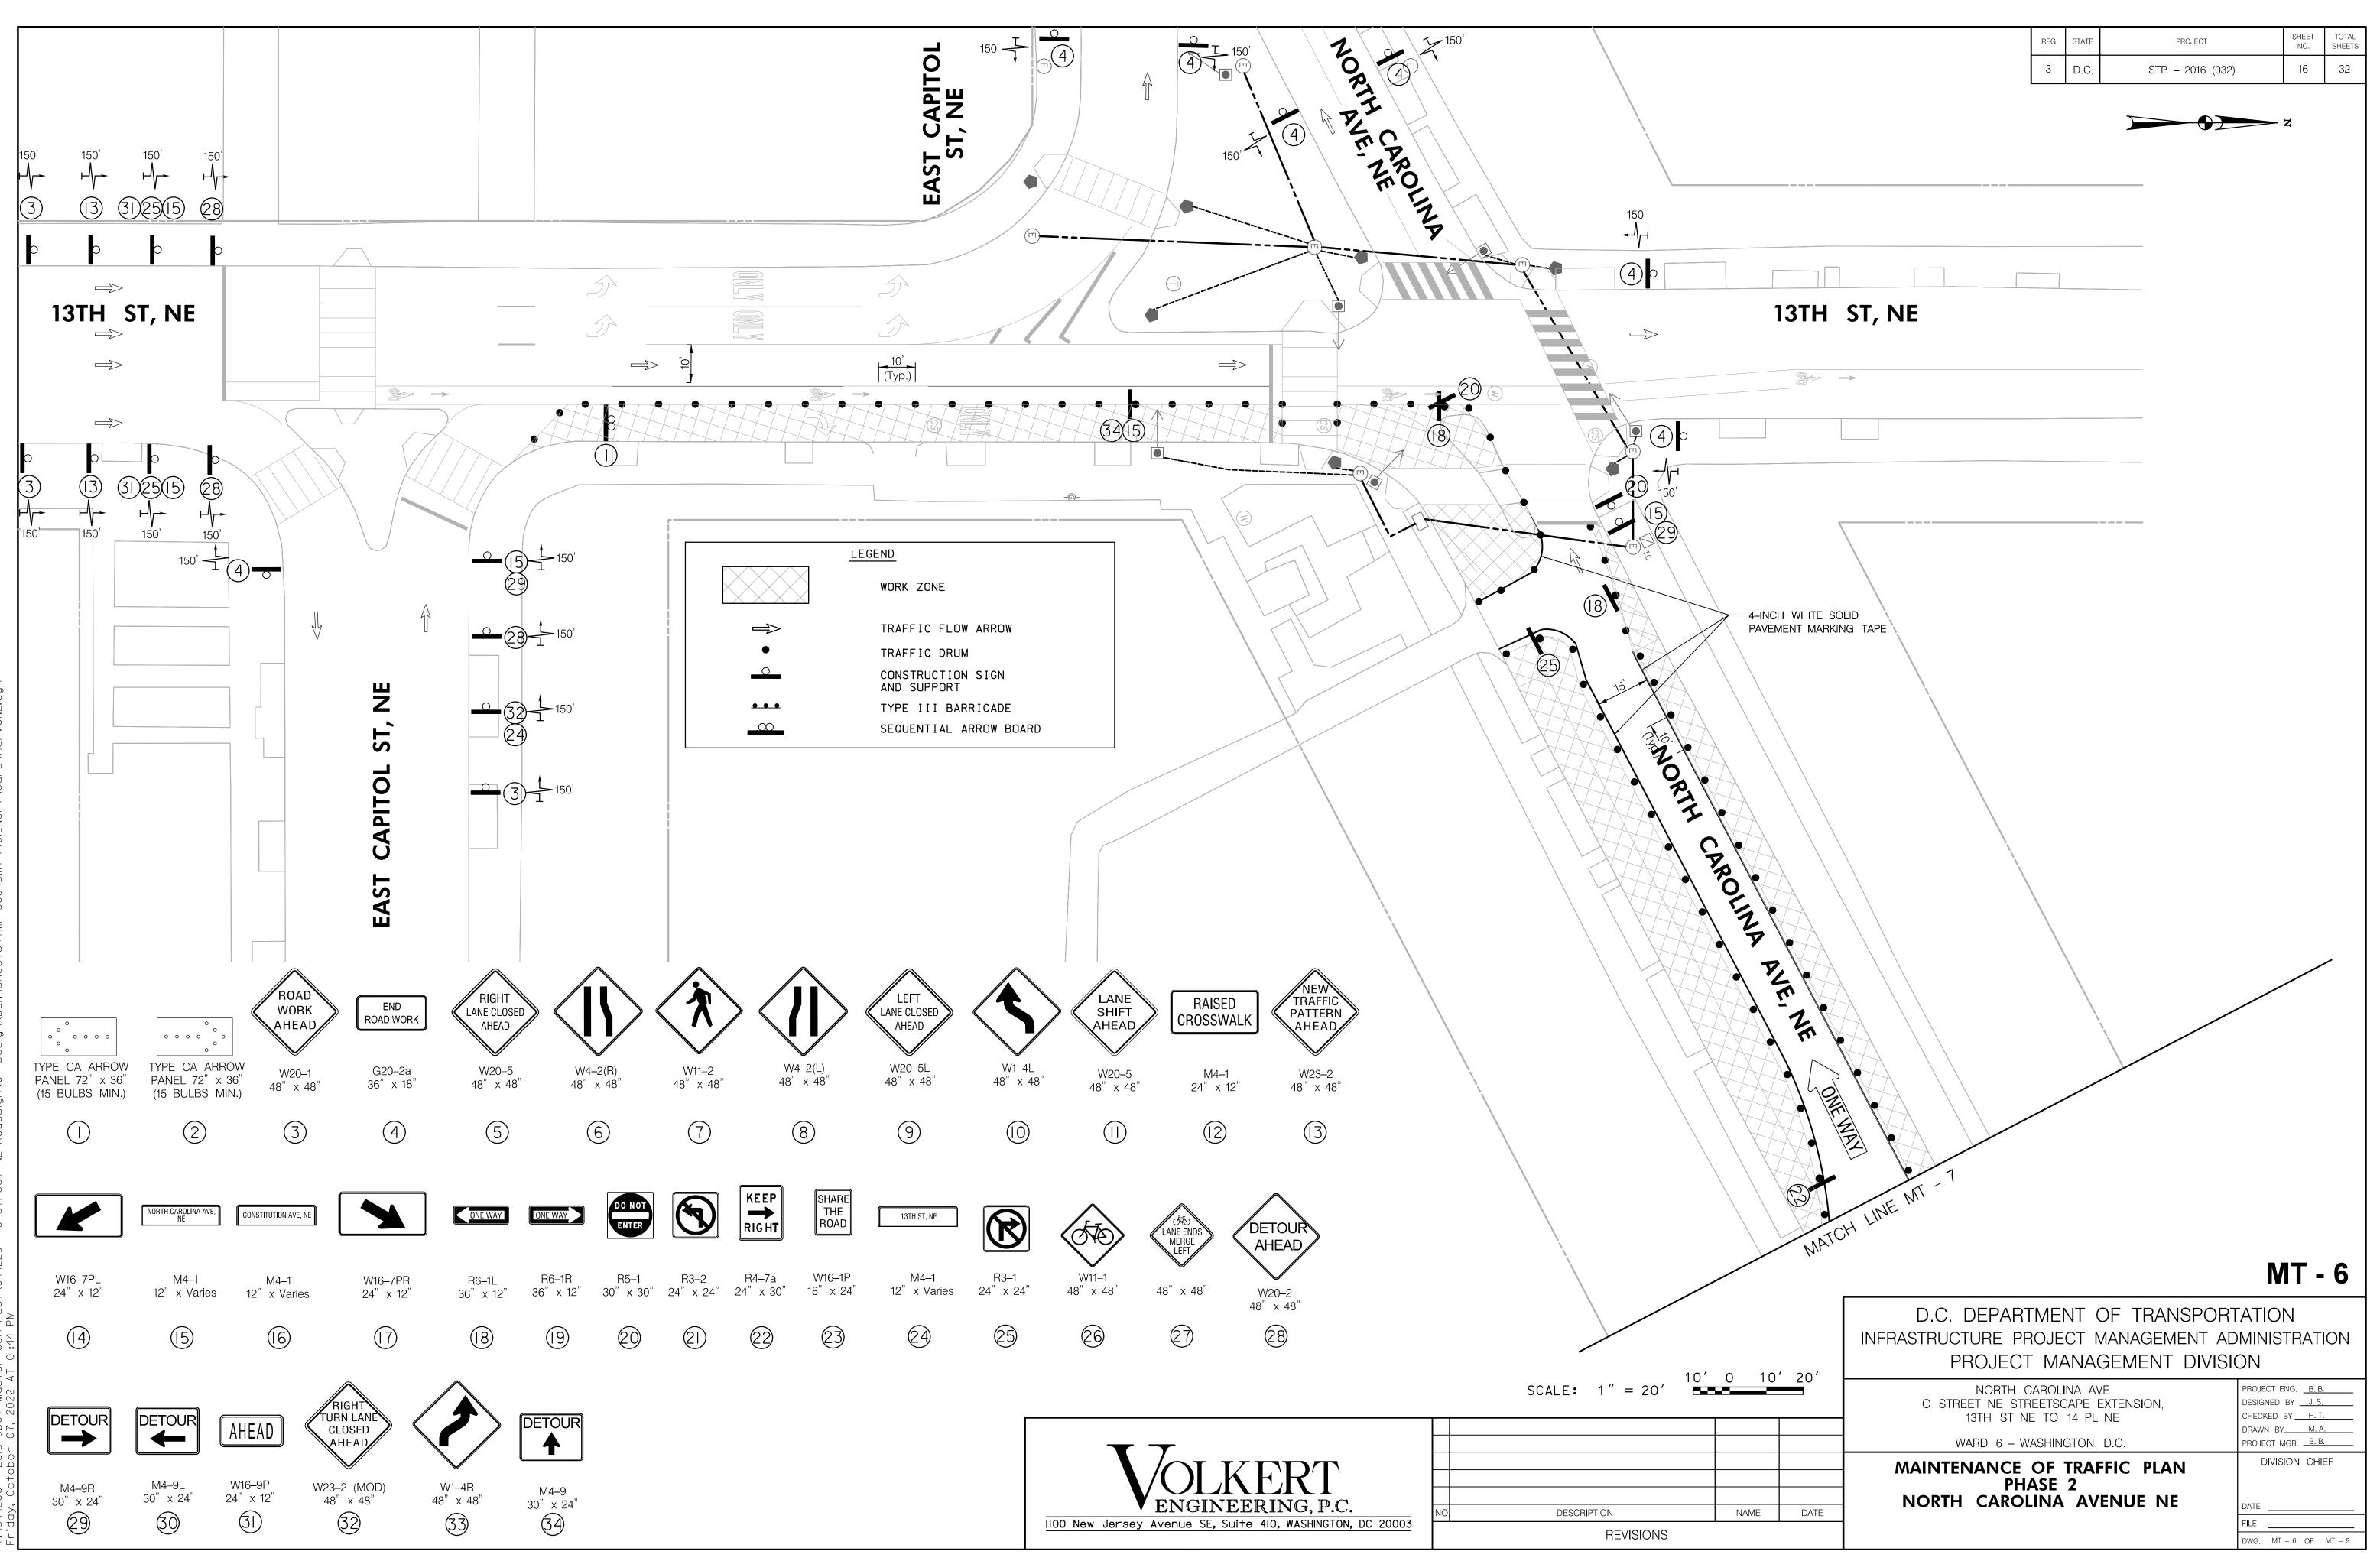
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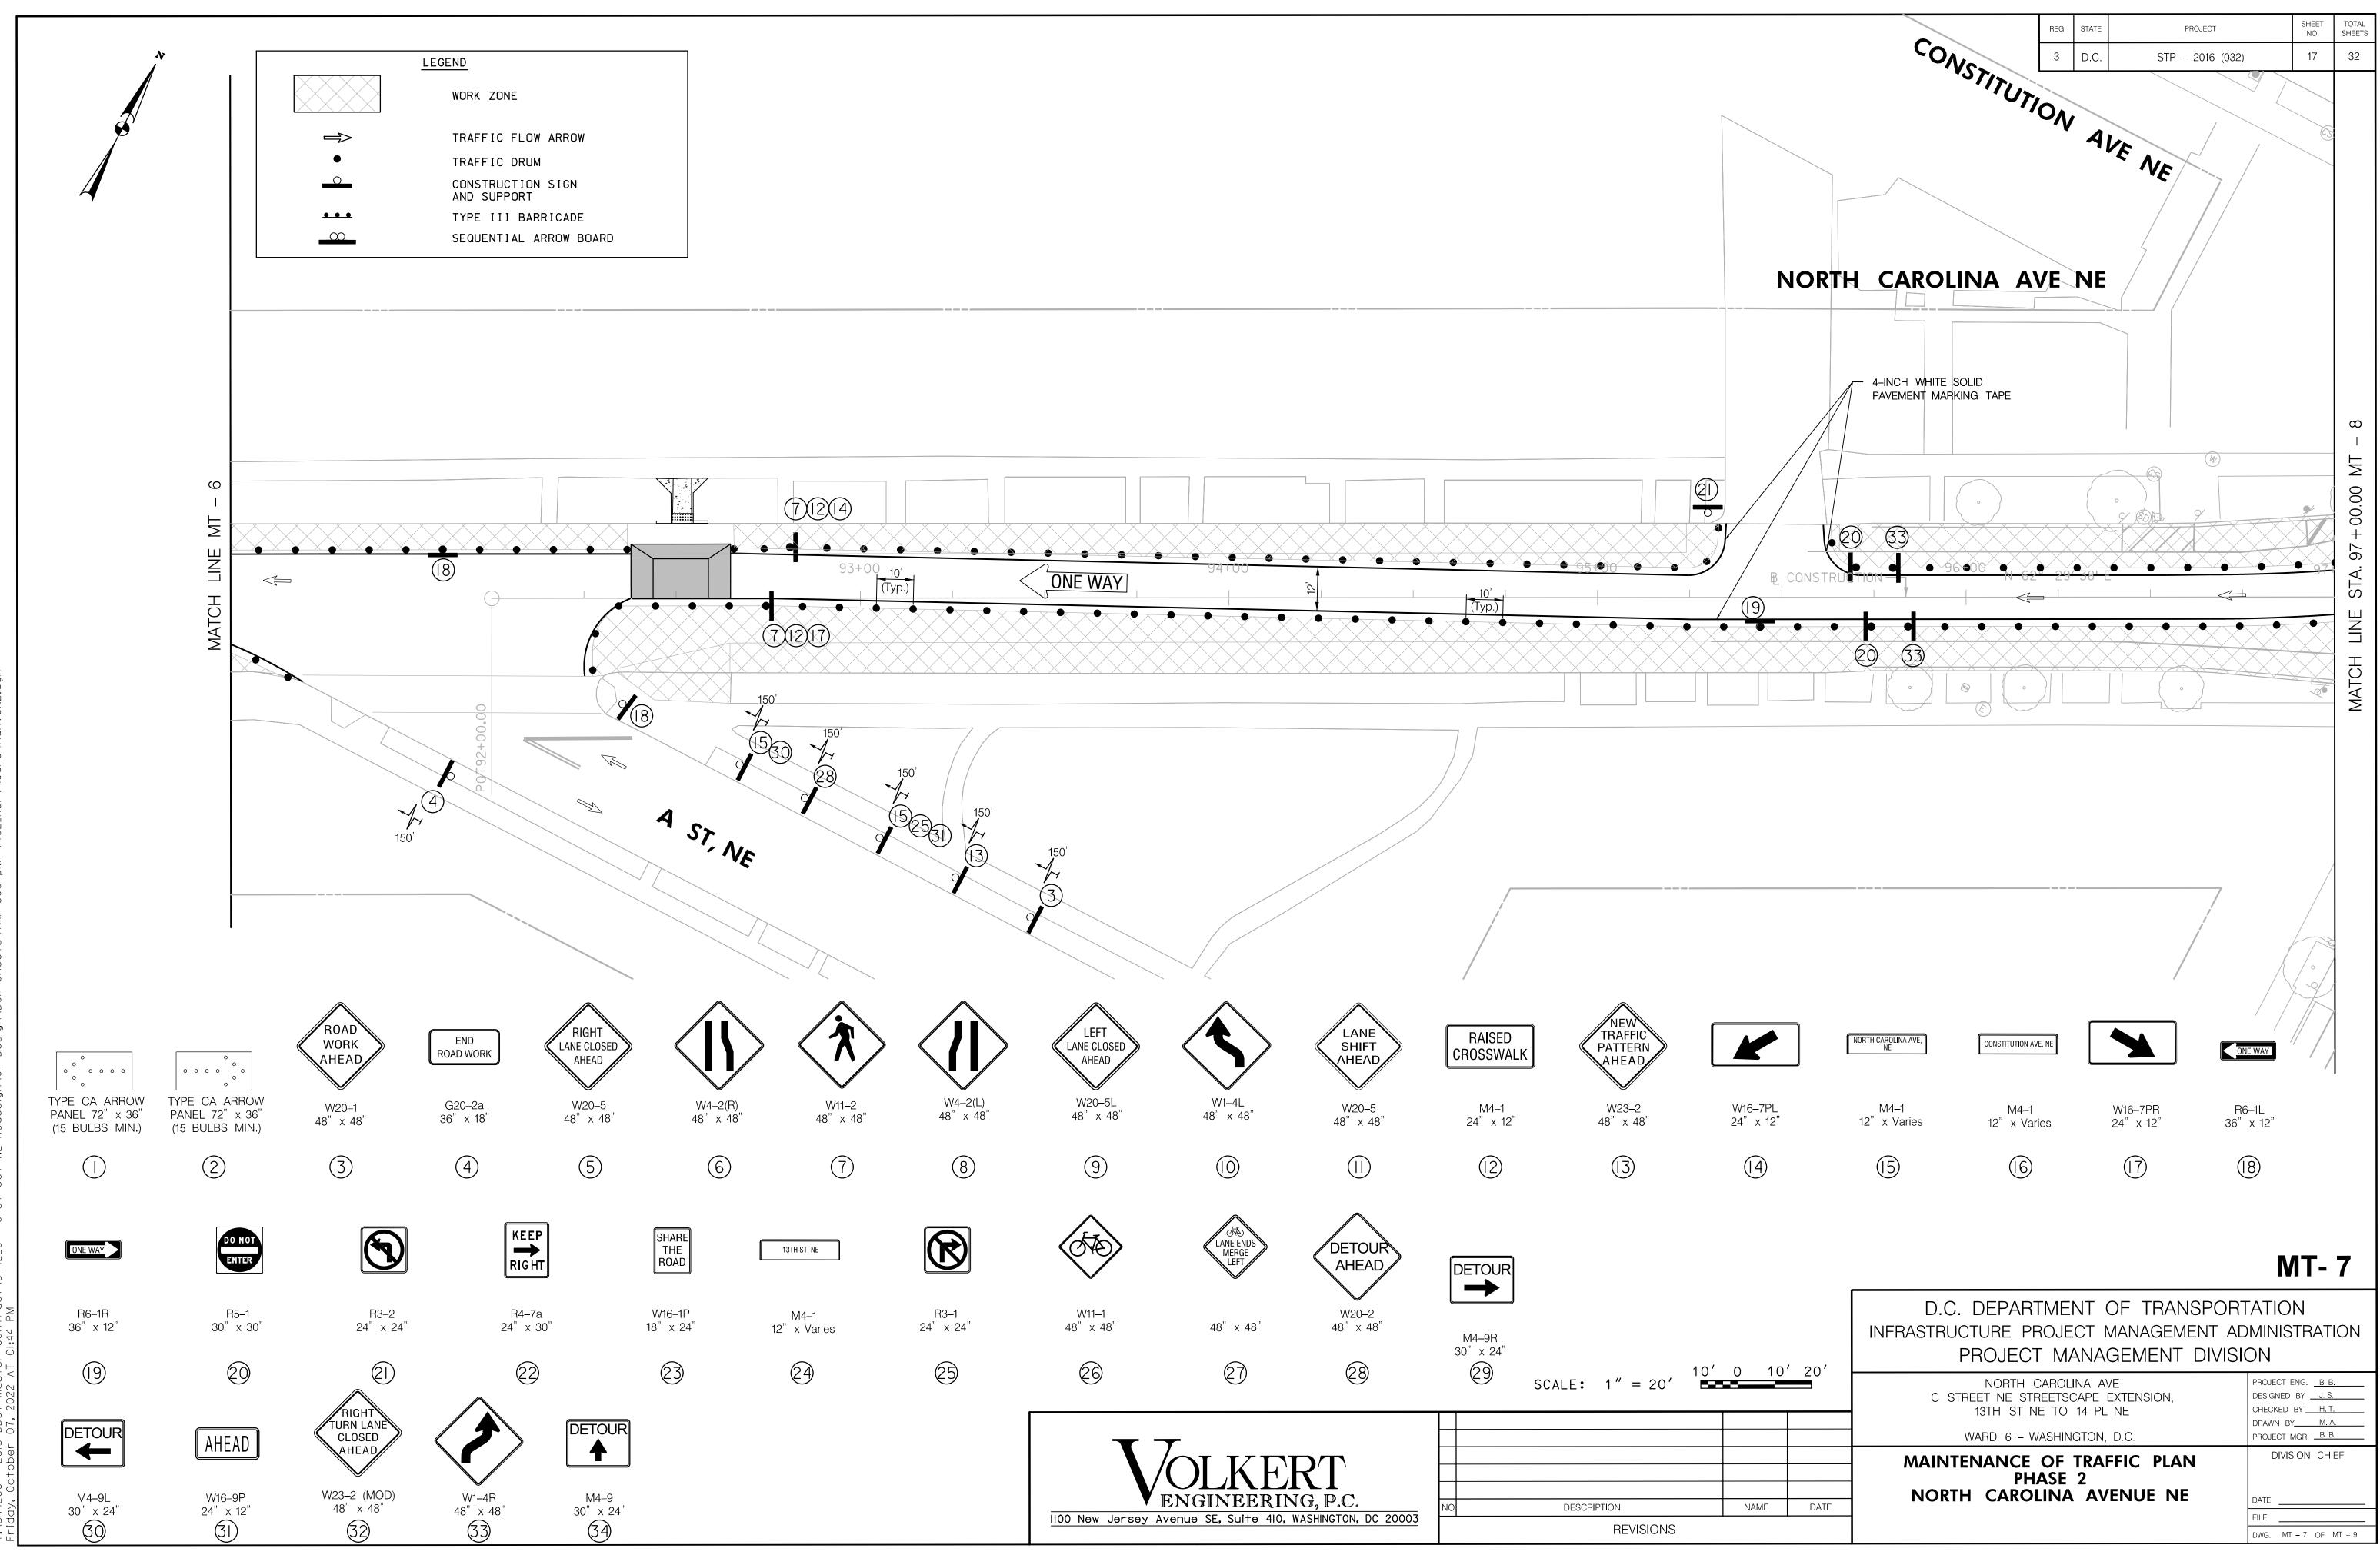


14200 - 2013 DD0T Master Contract/344229 - C Street NE Redesign/07 Design/DGN/Sheets/TMP-SOC/pMT-P003_NorthCarolingAv

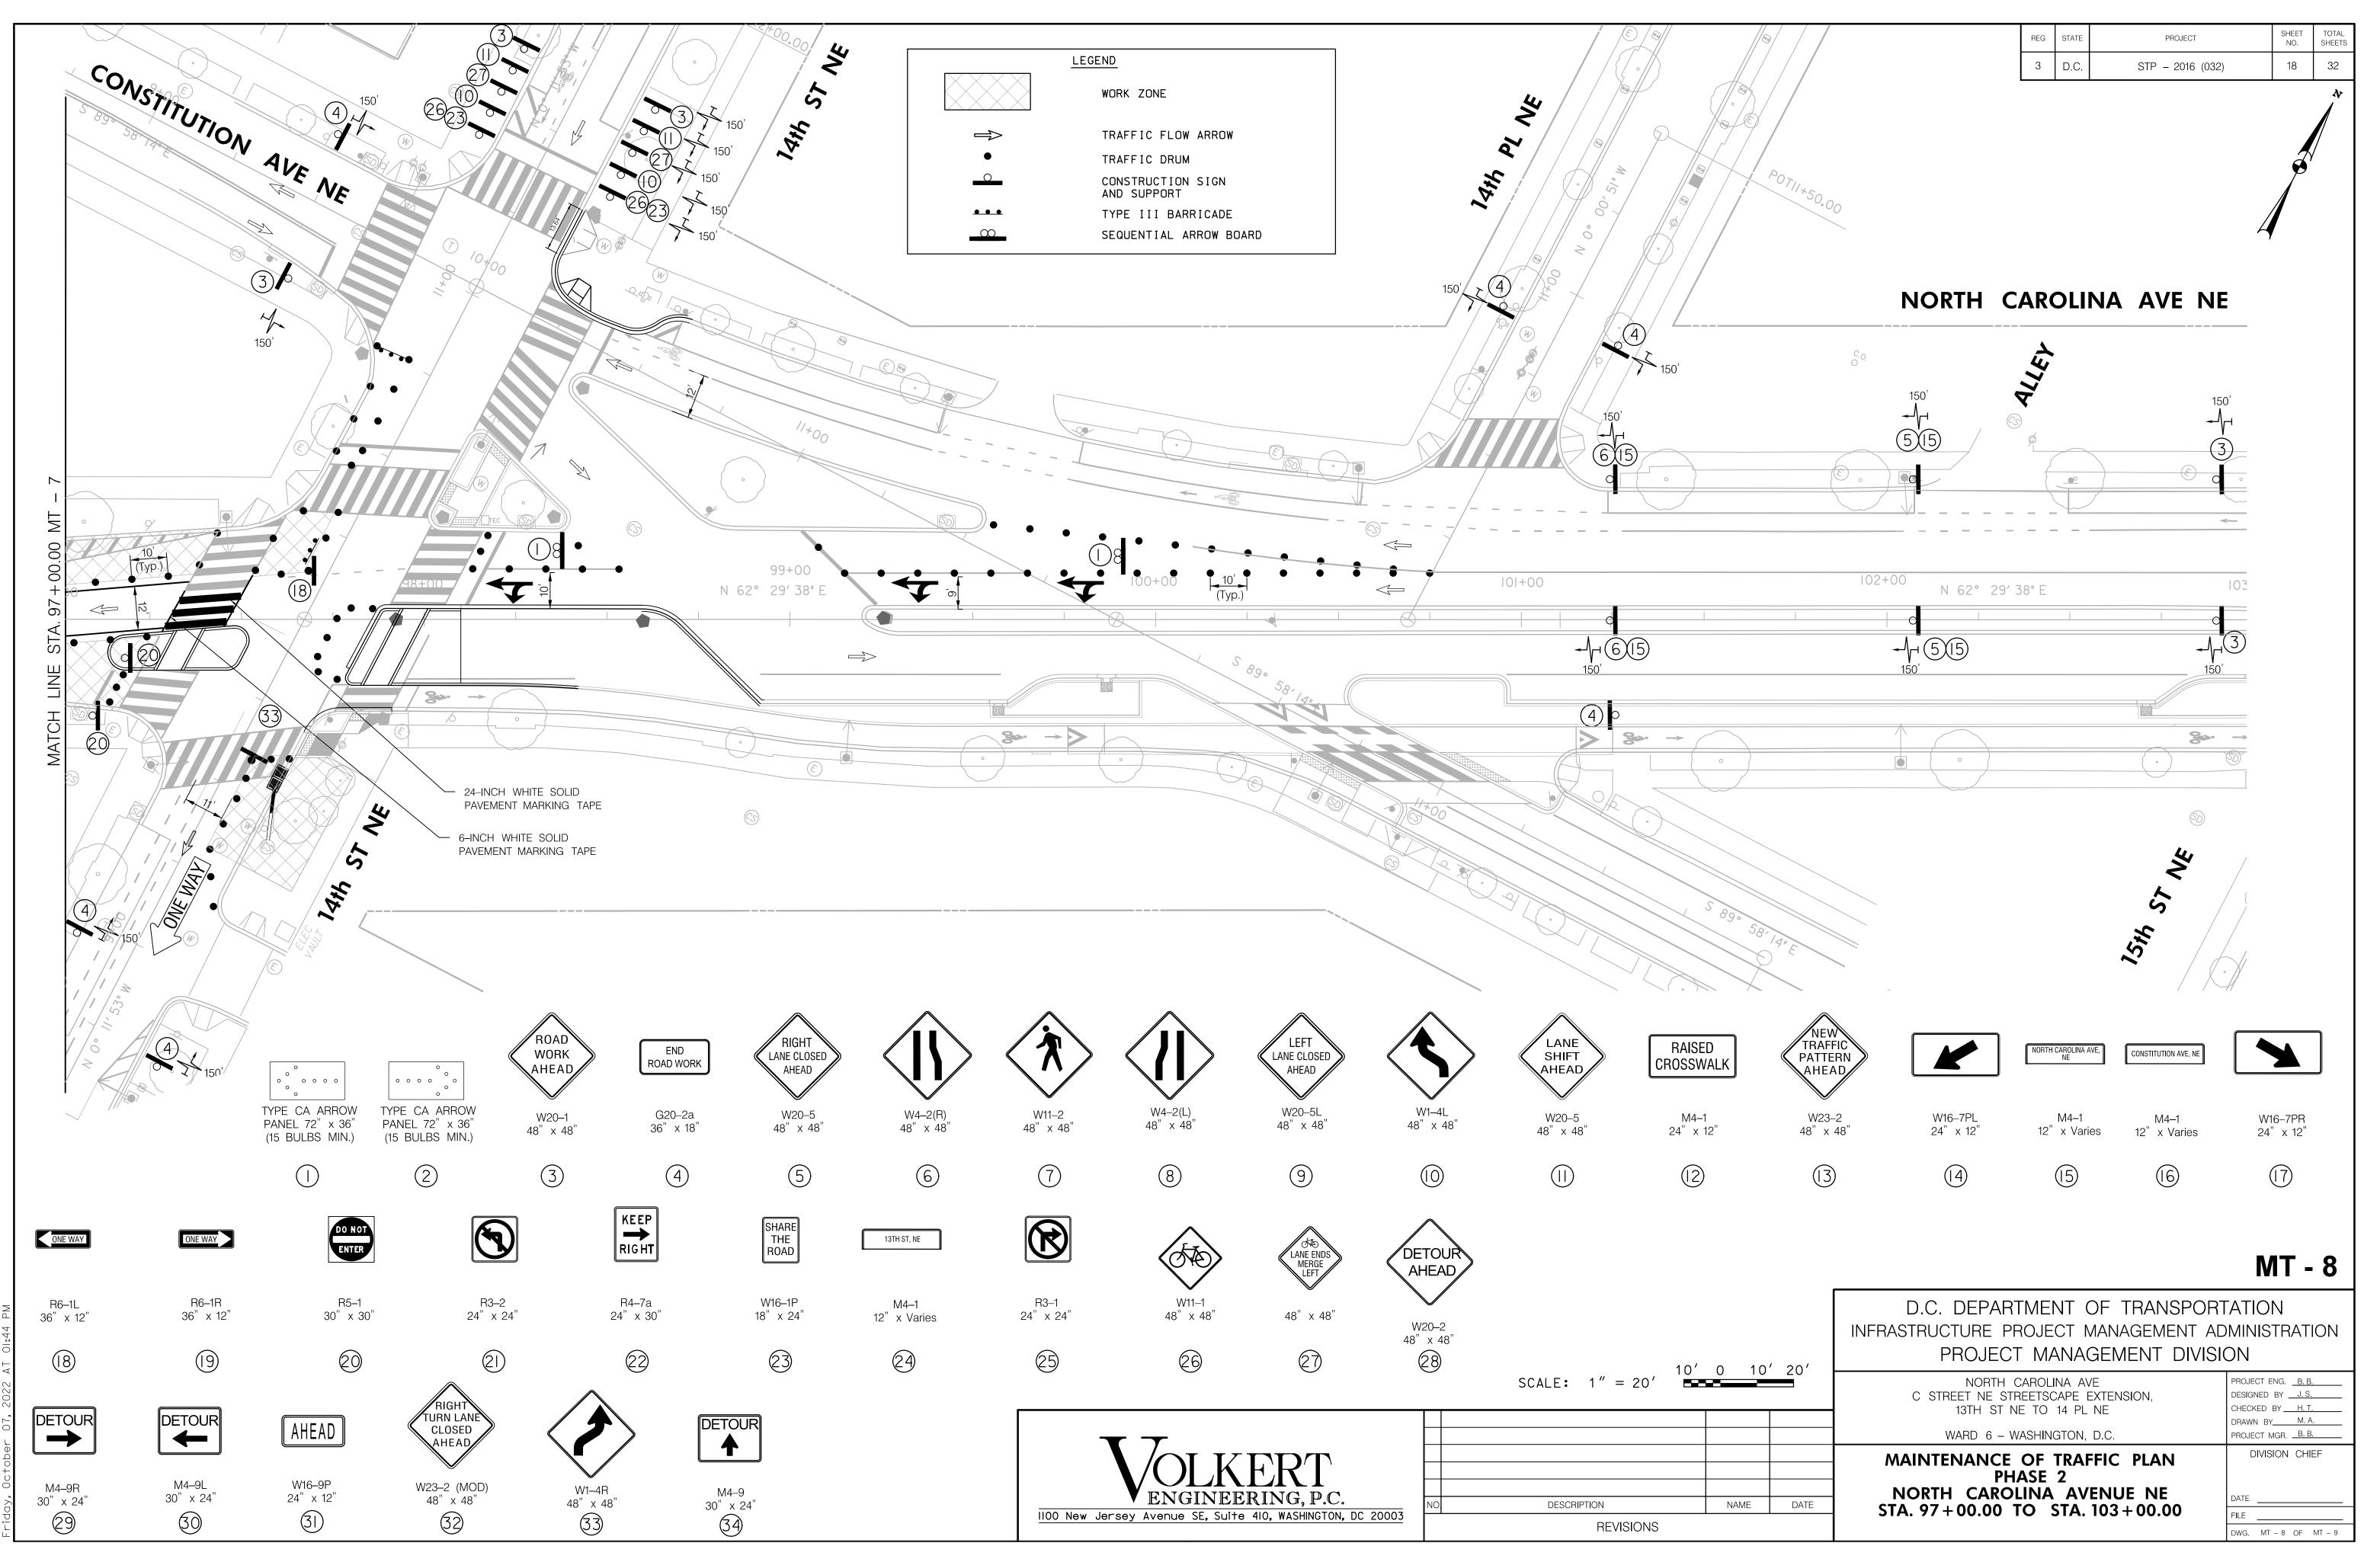


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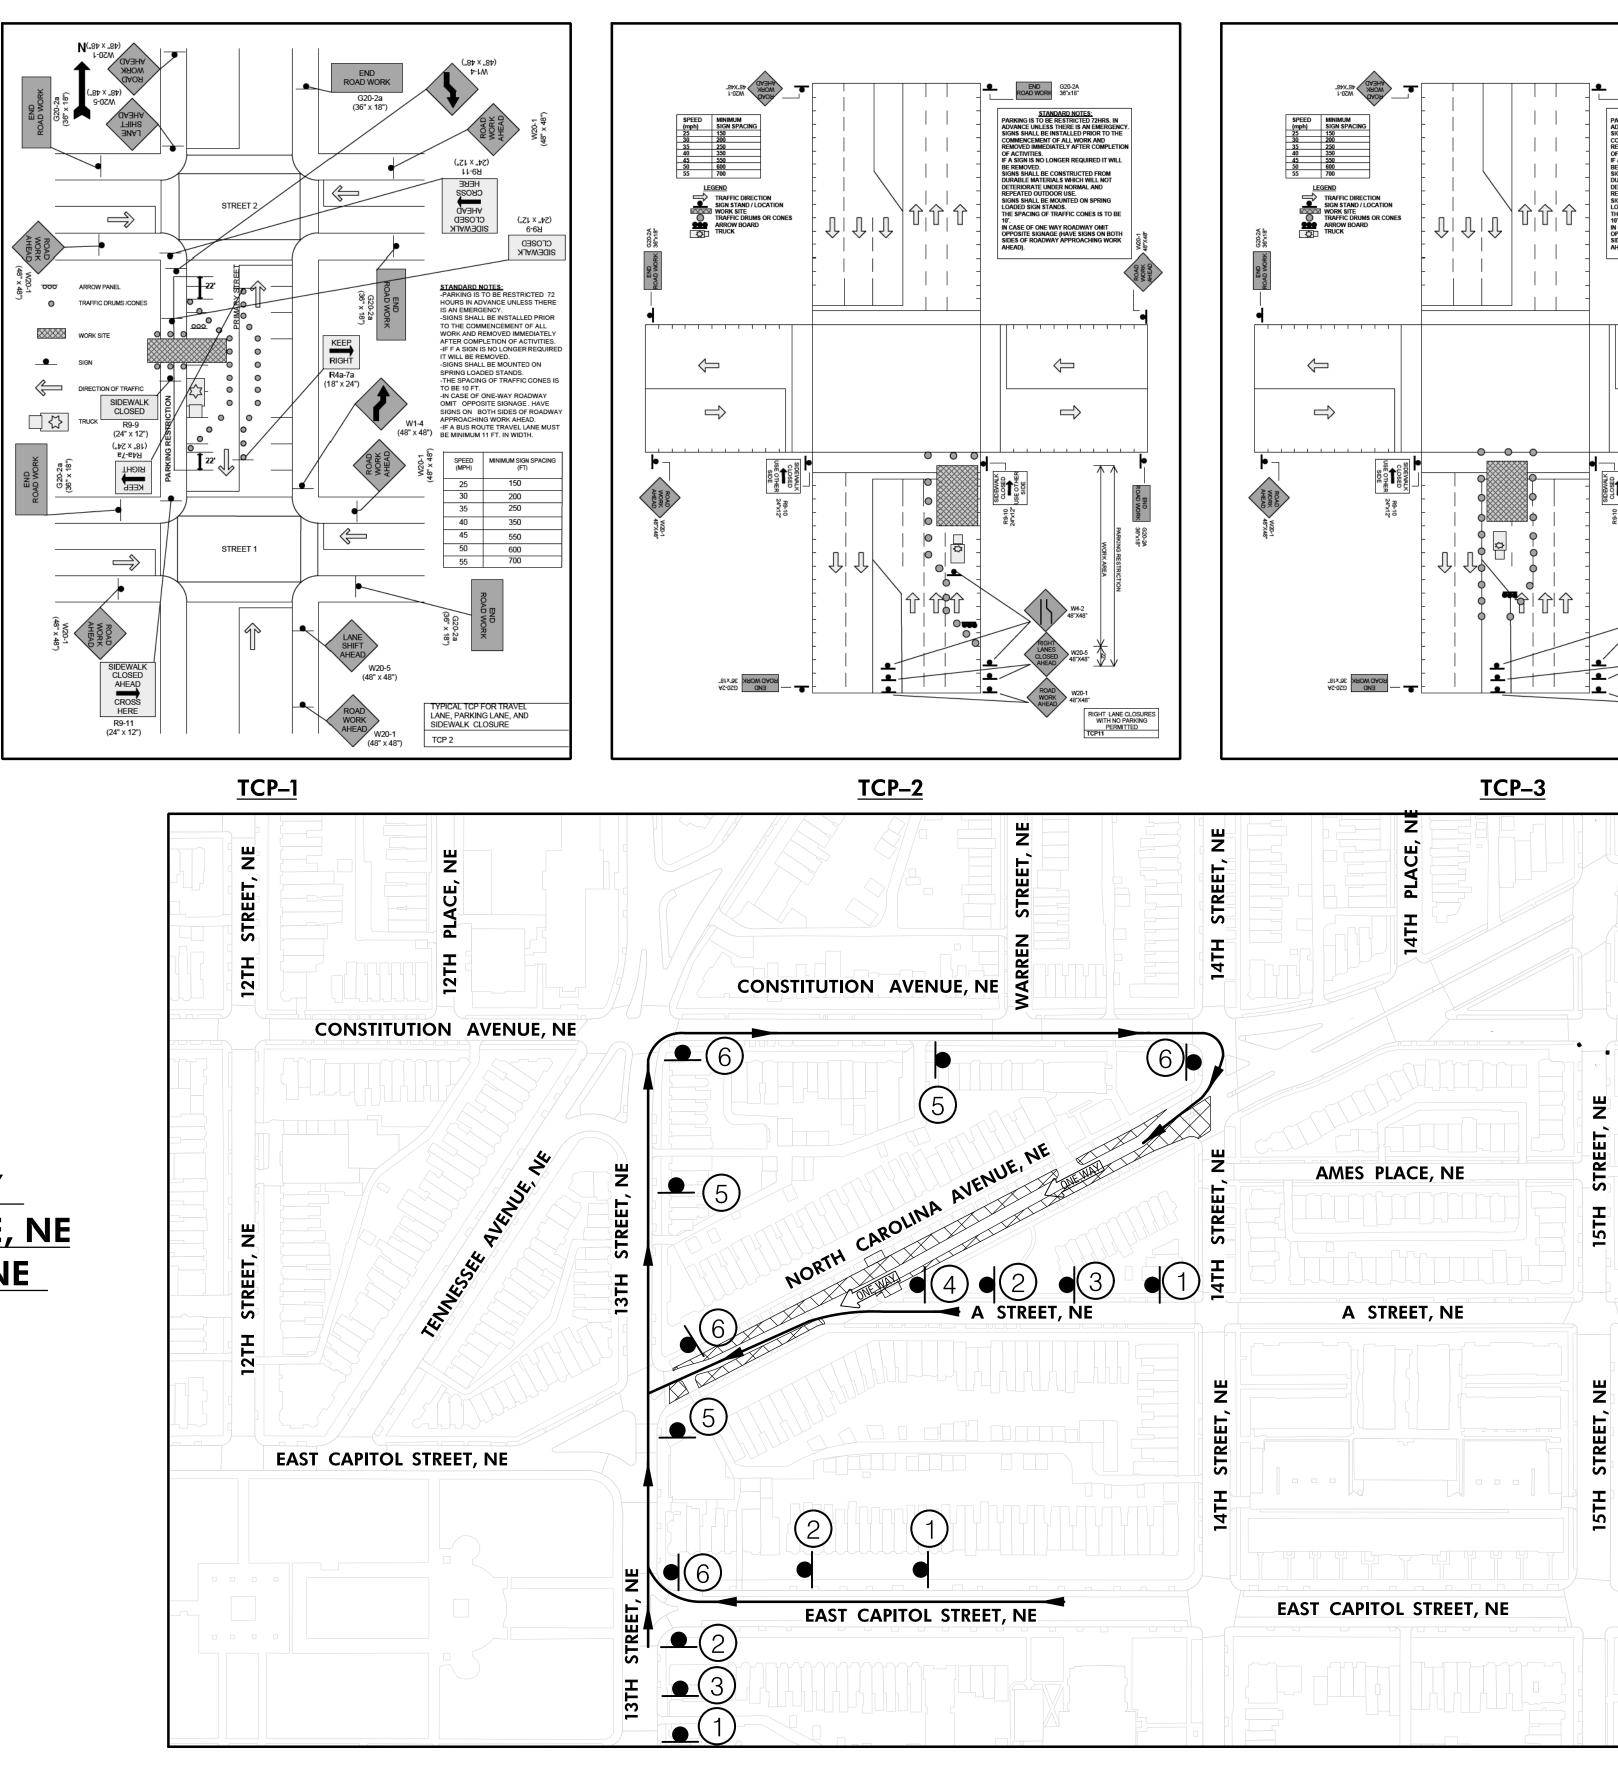
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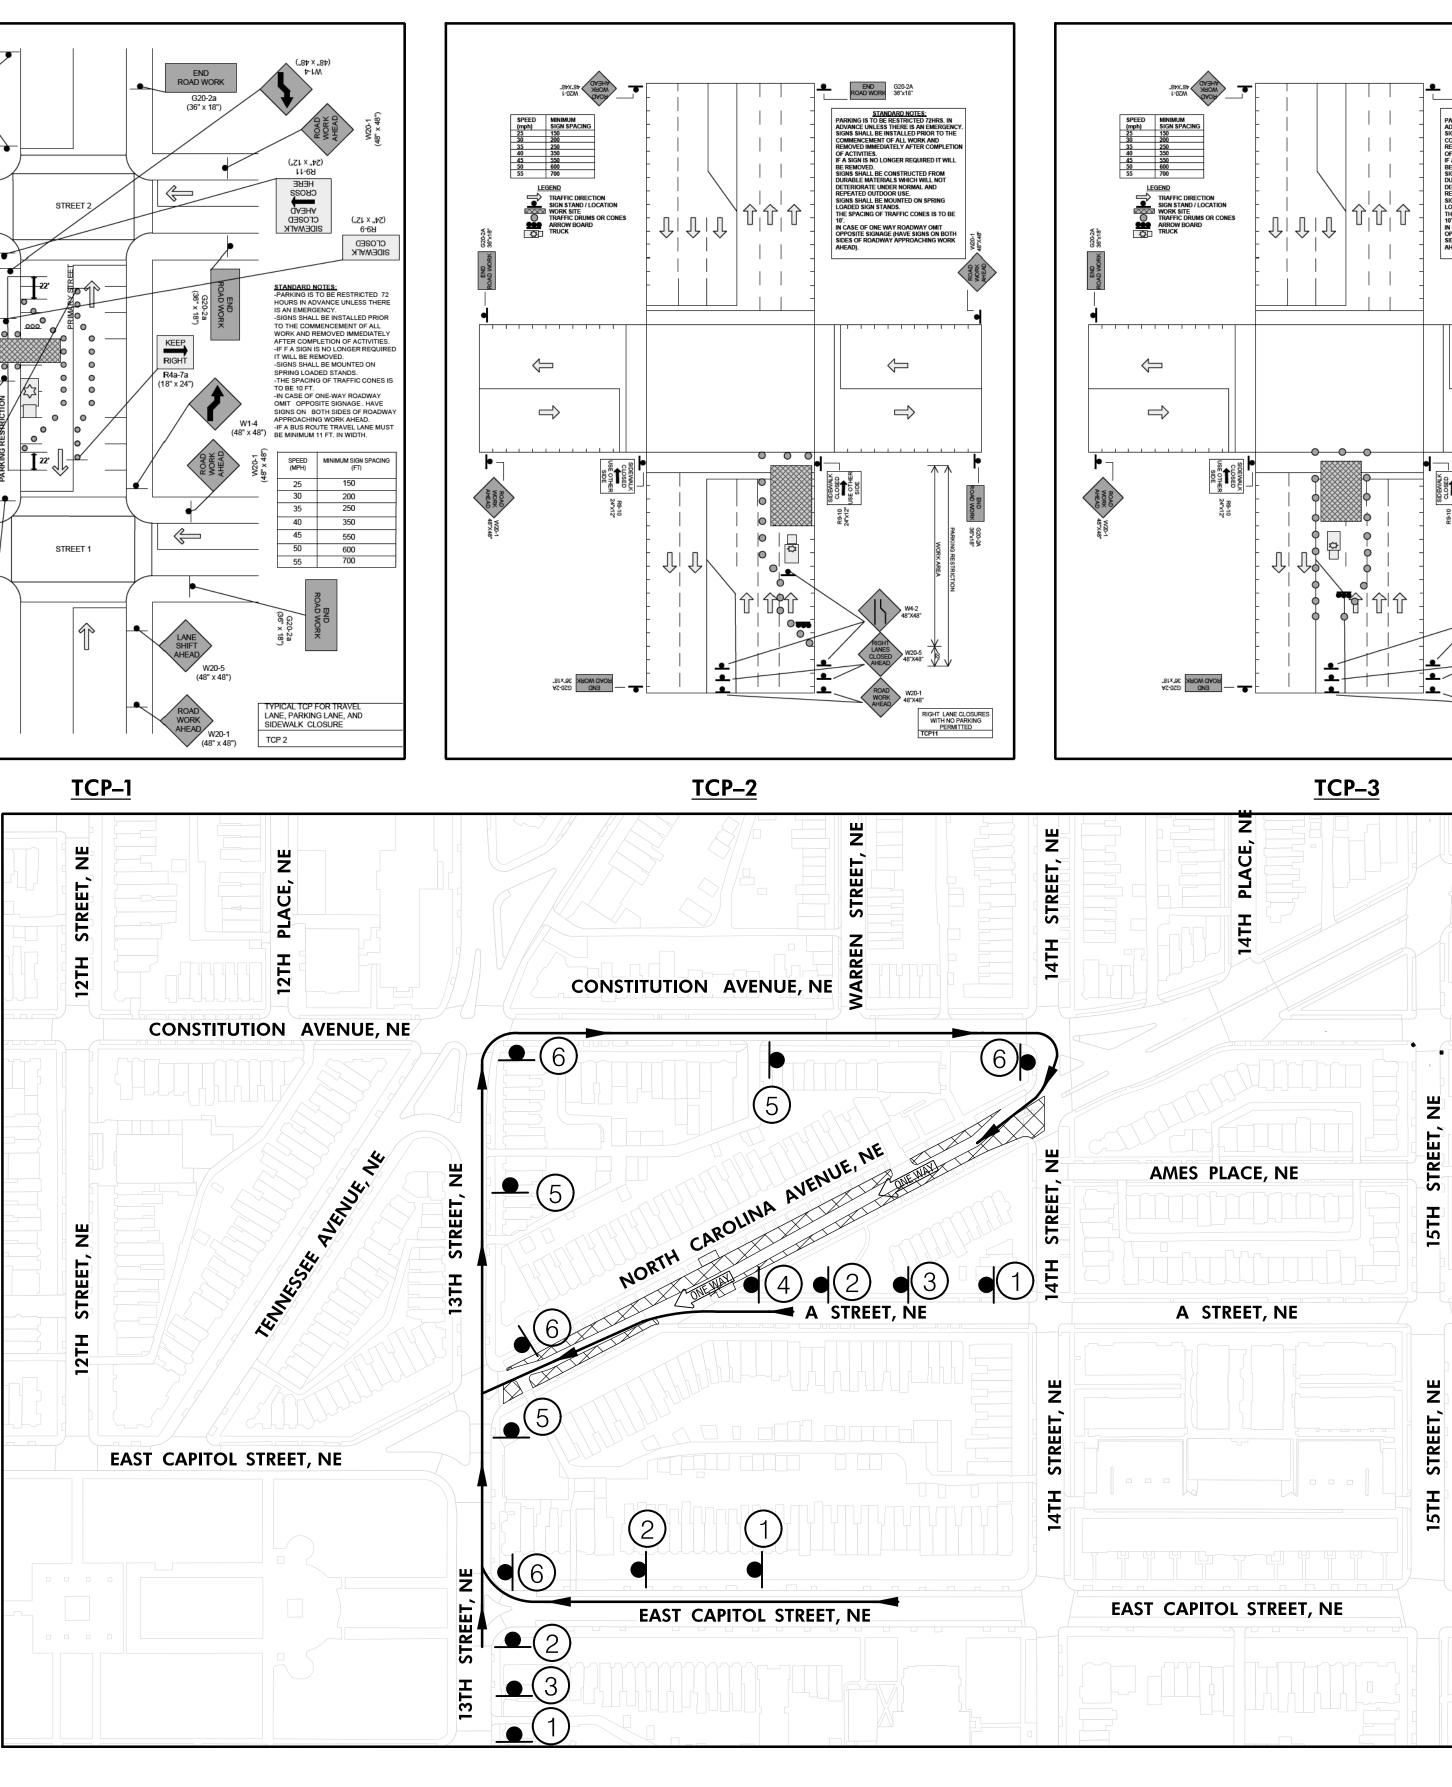


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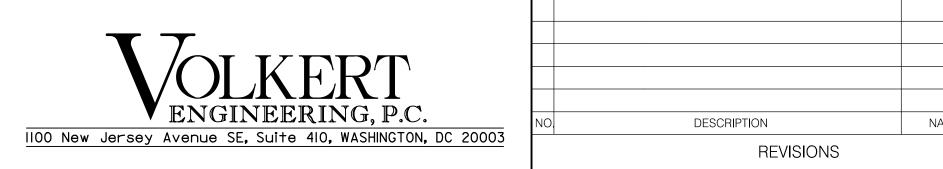


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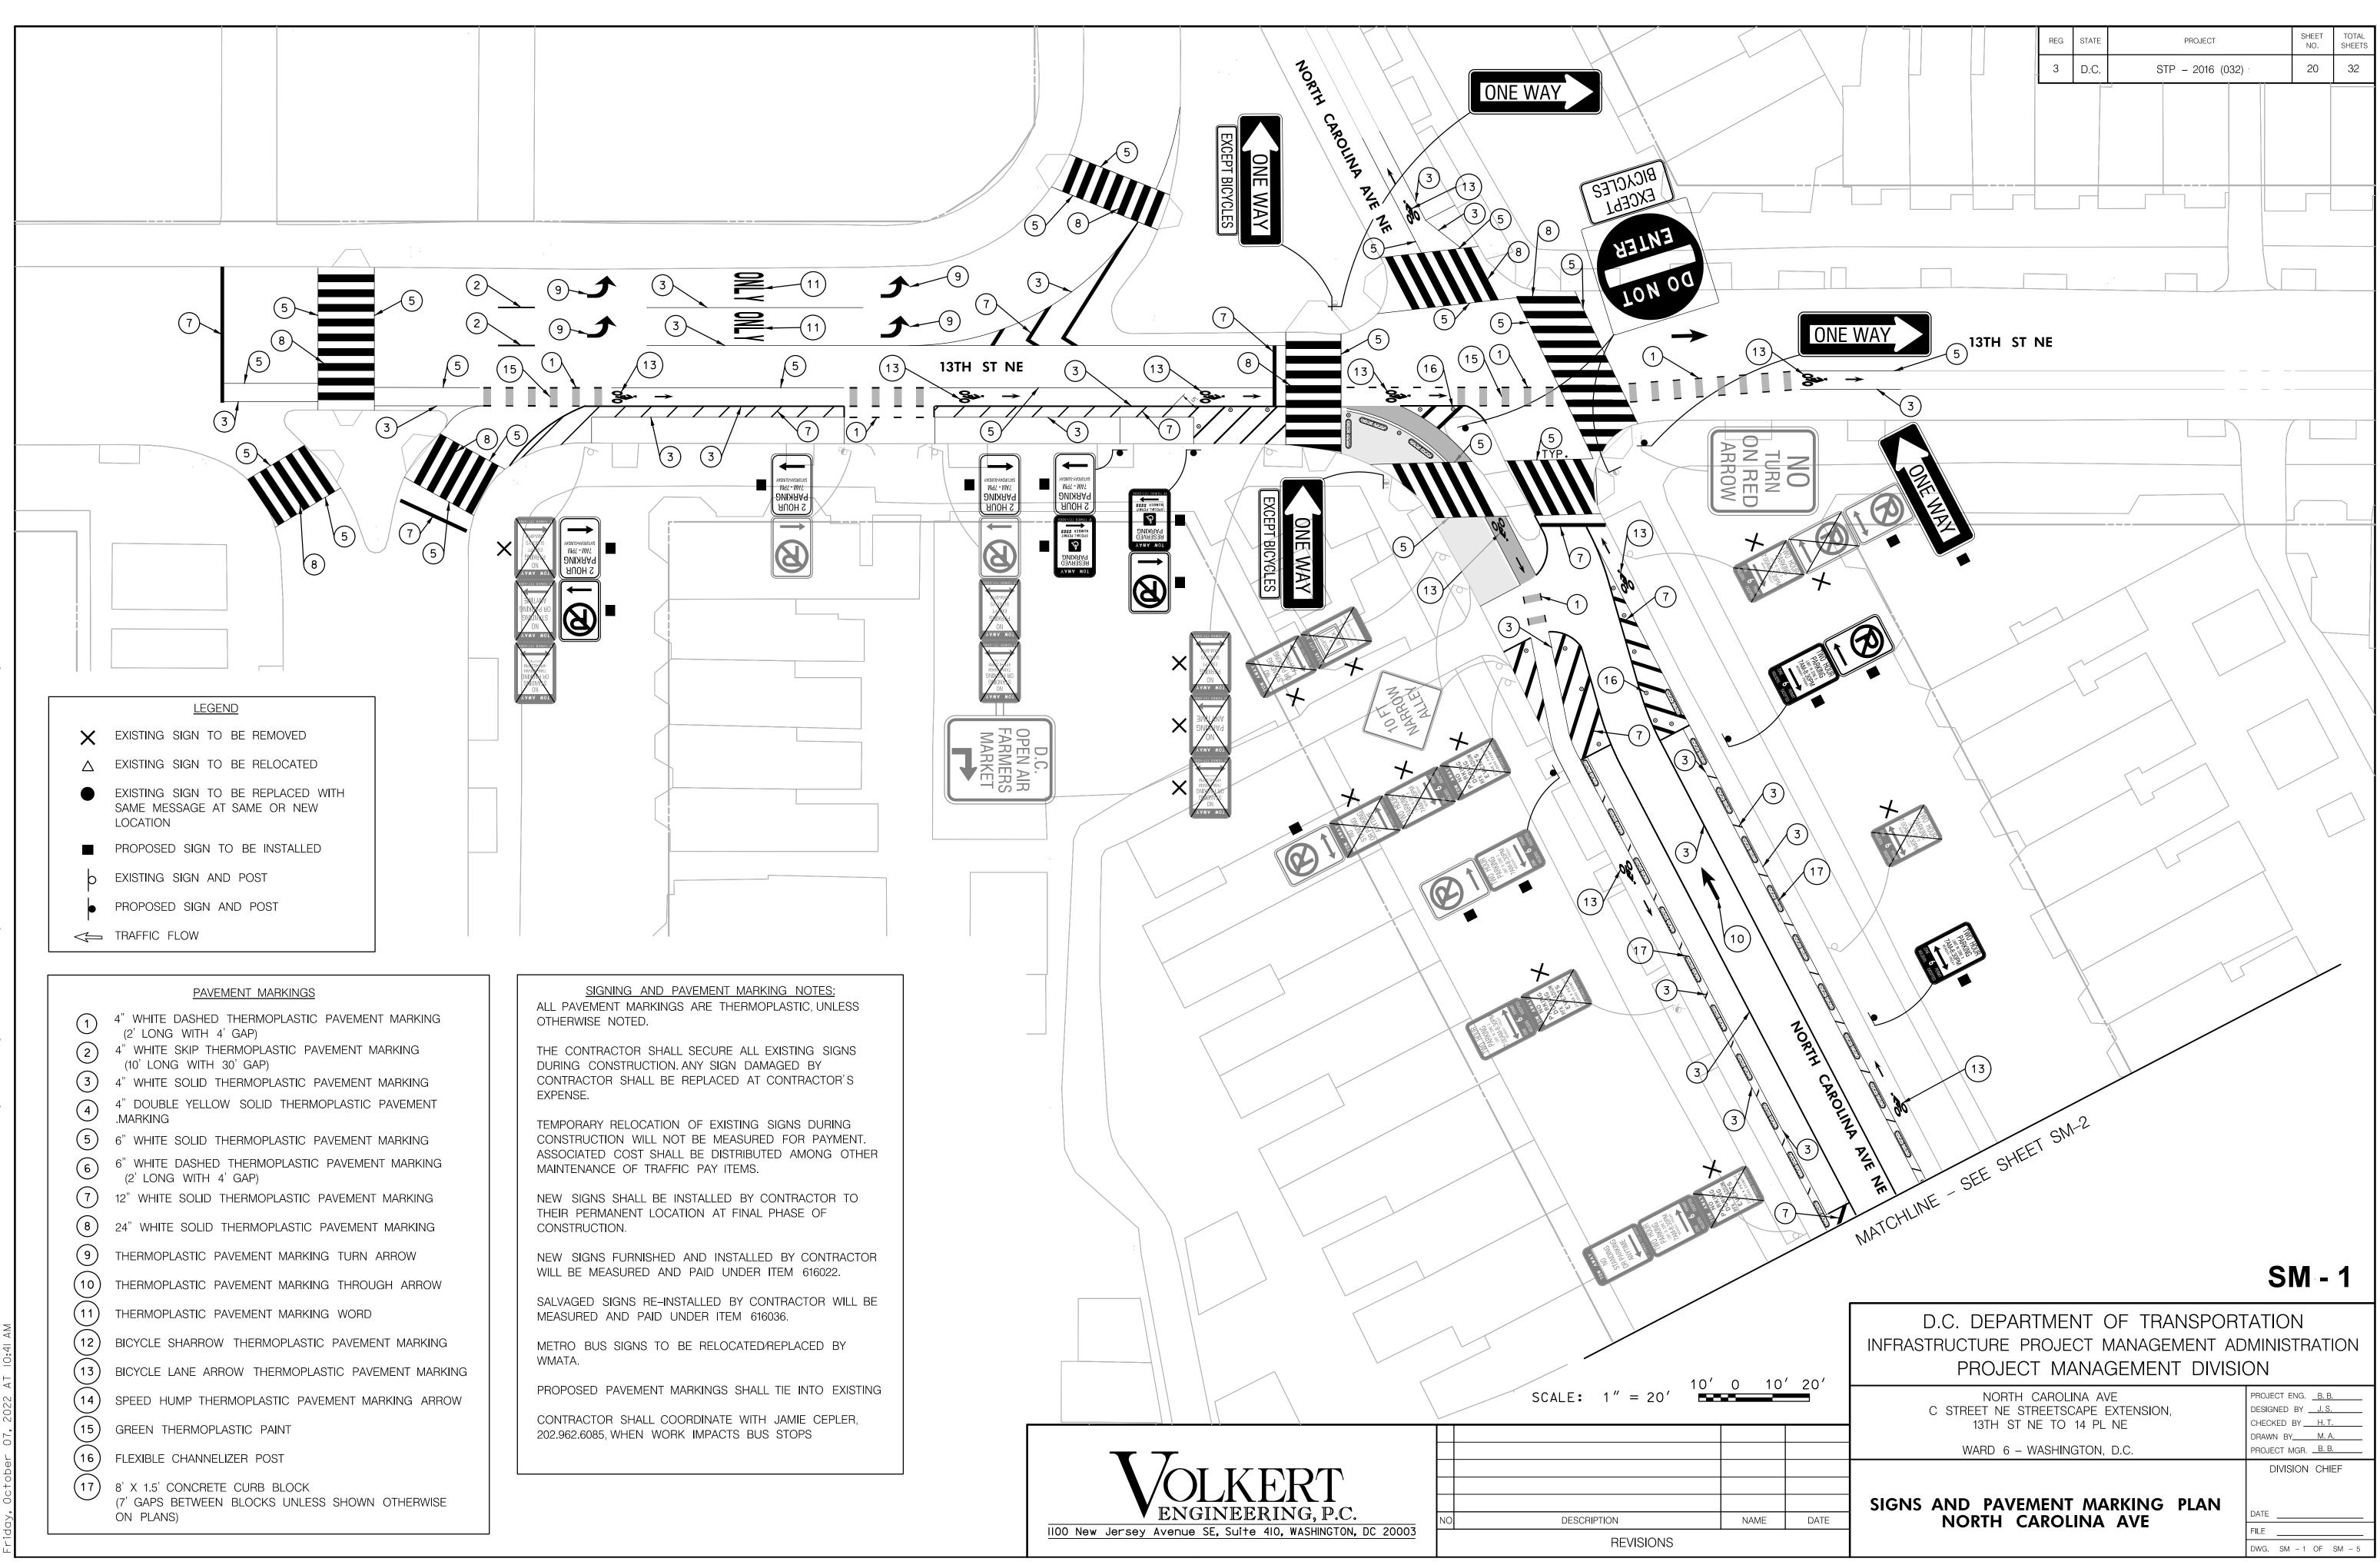


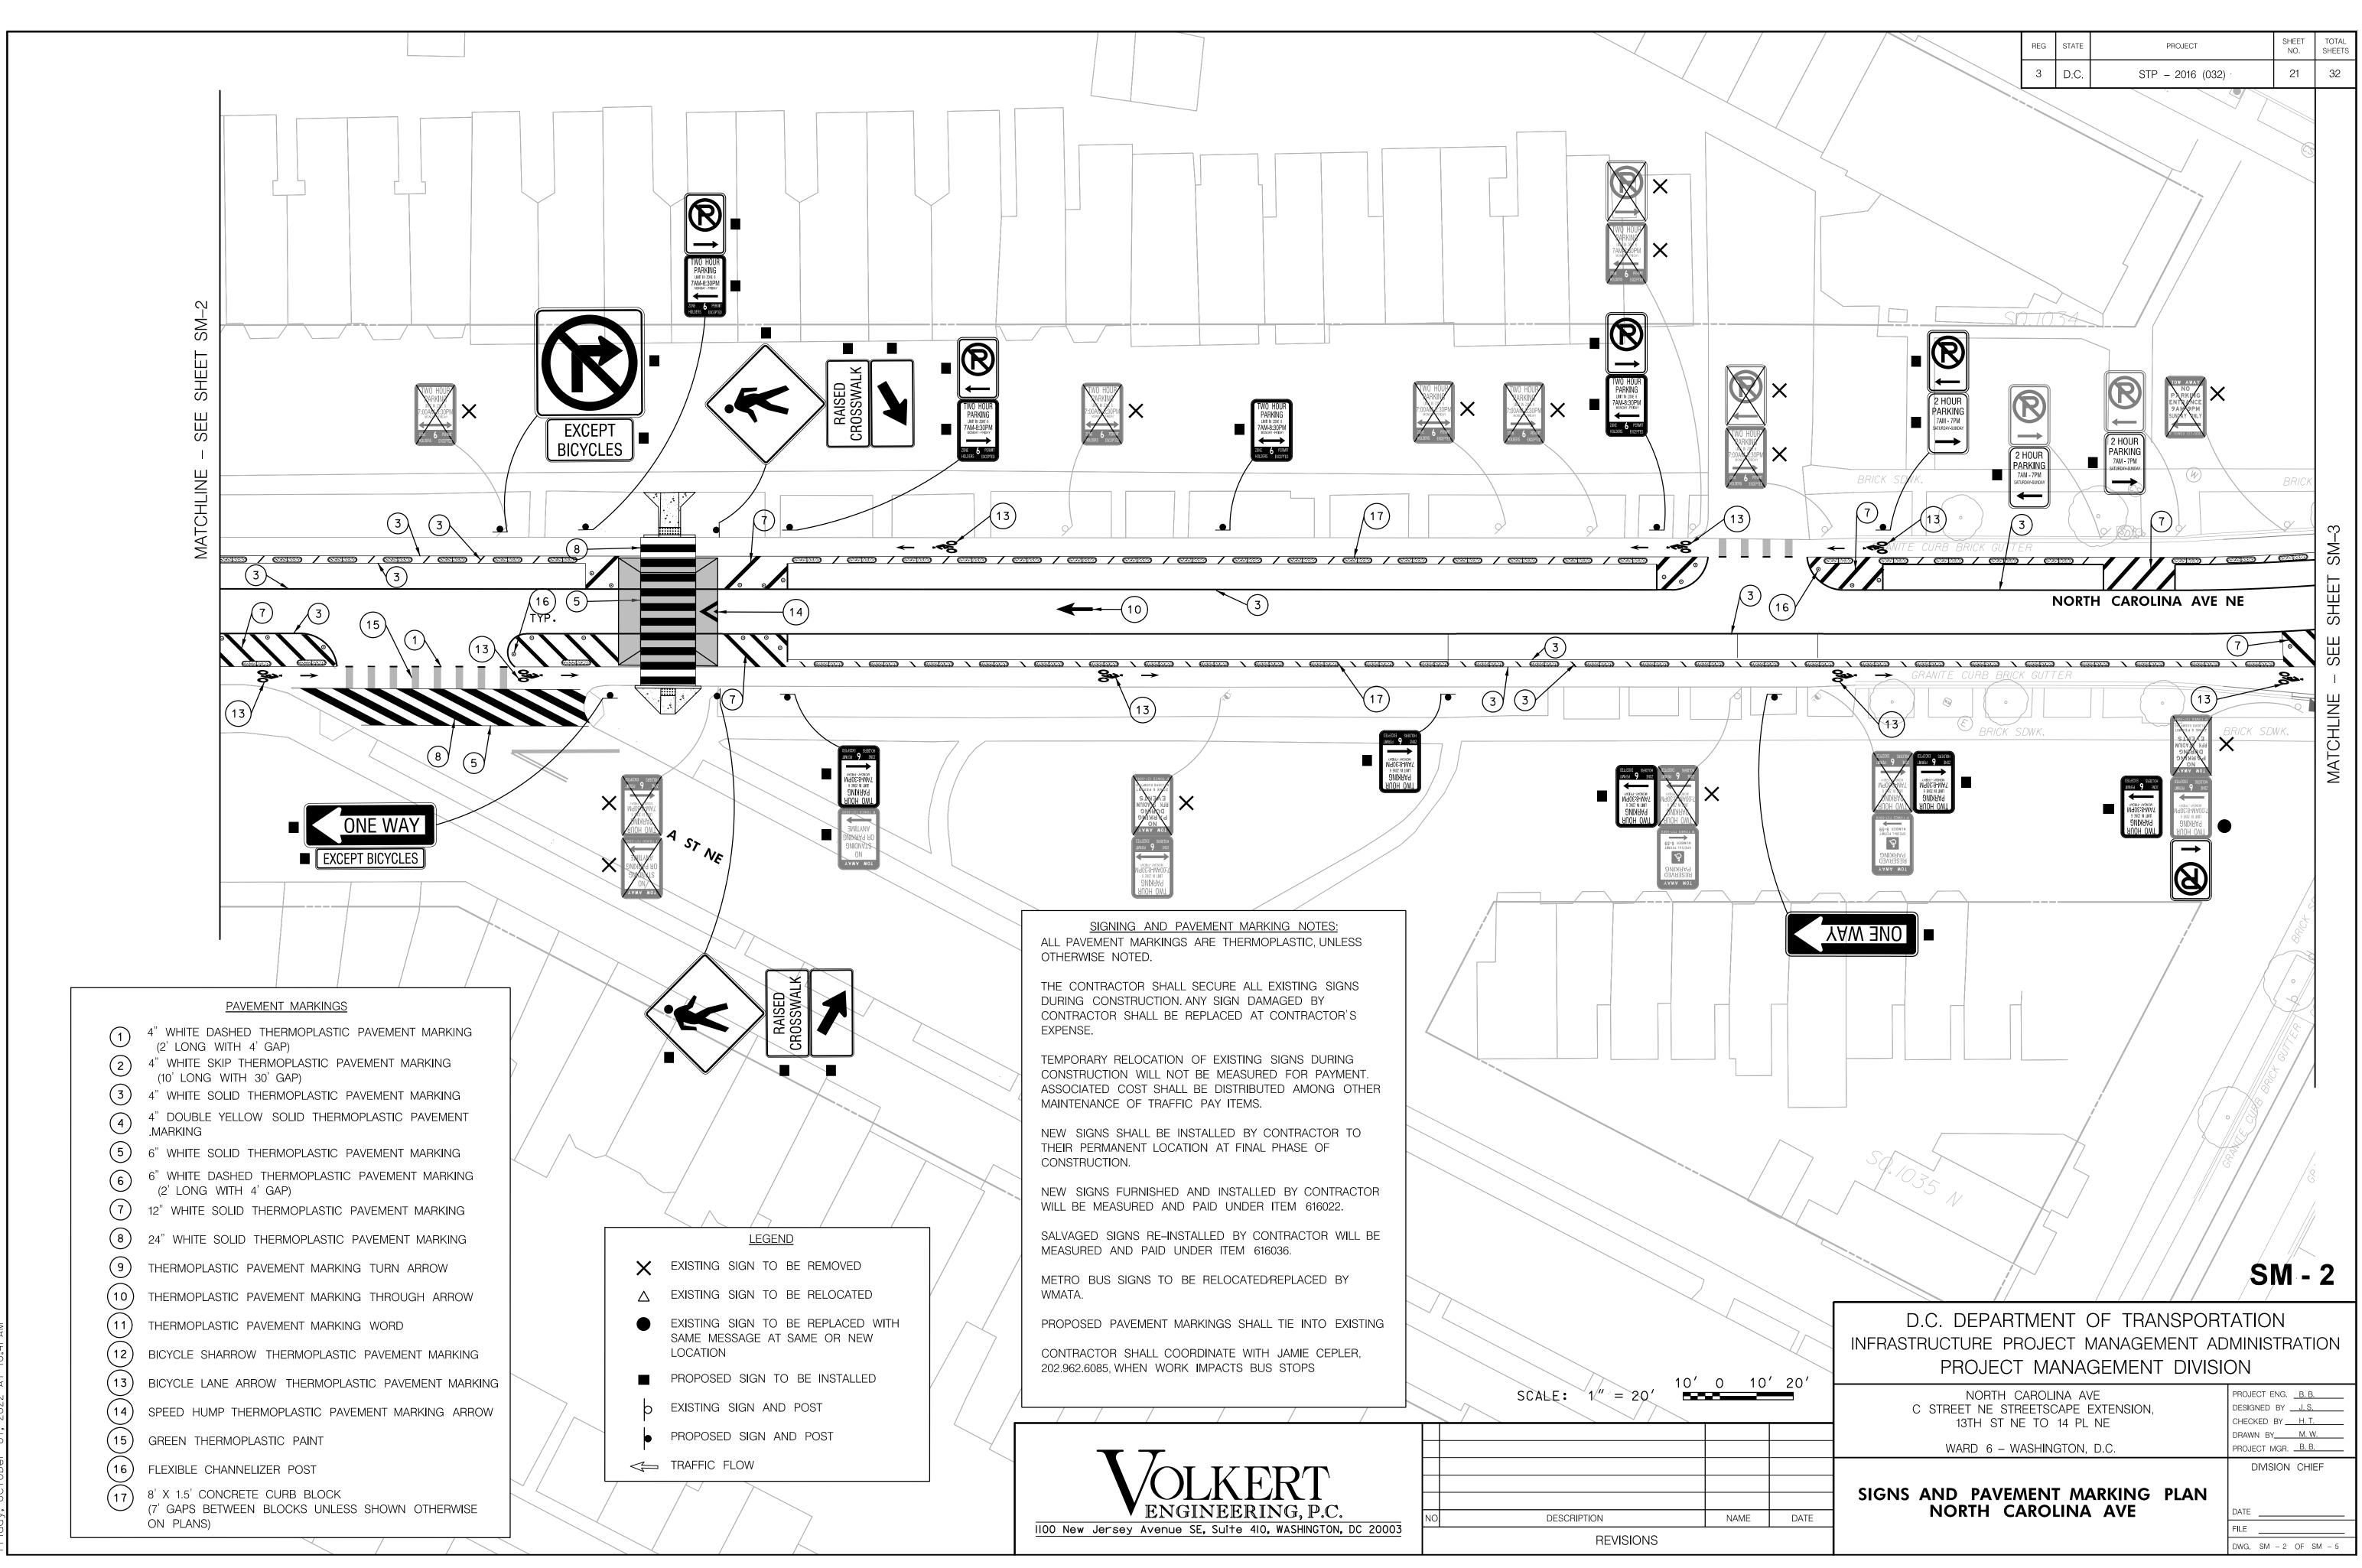


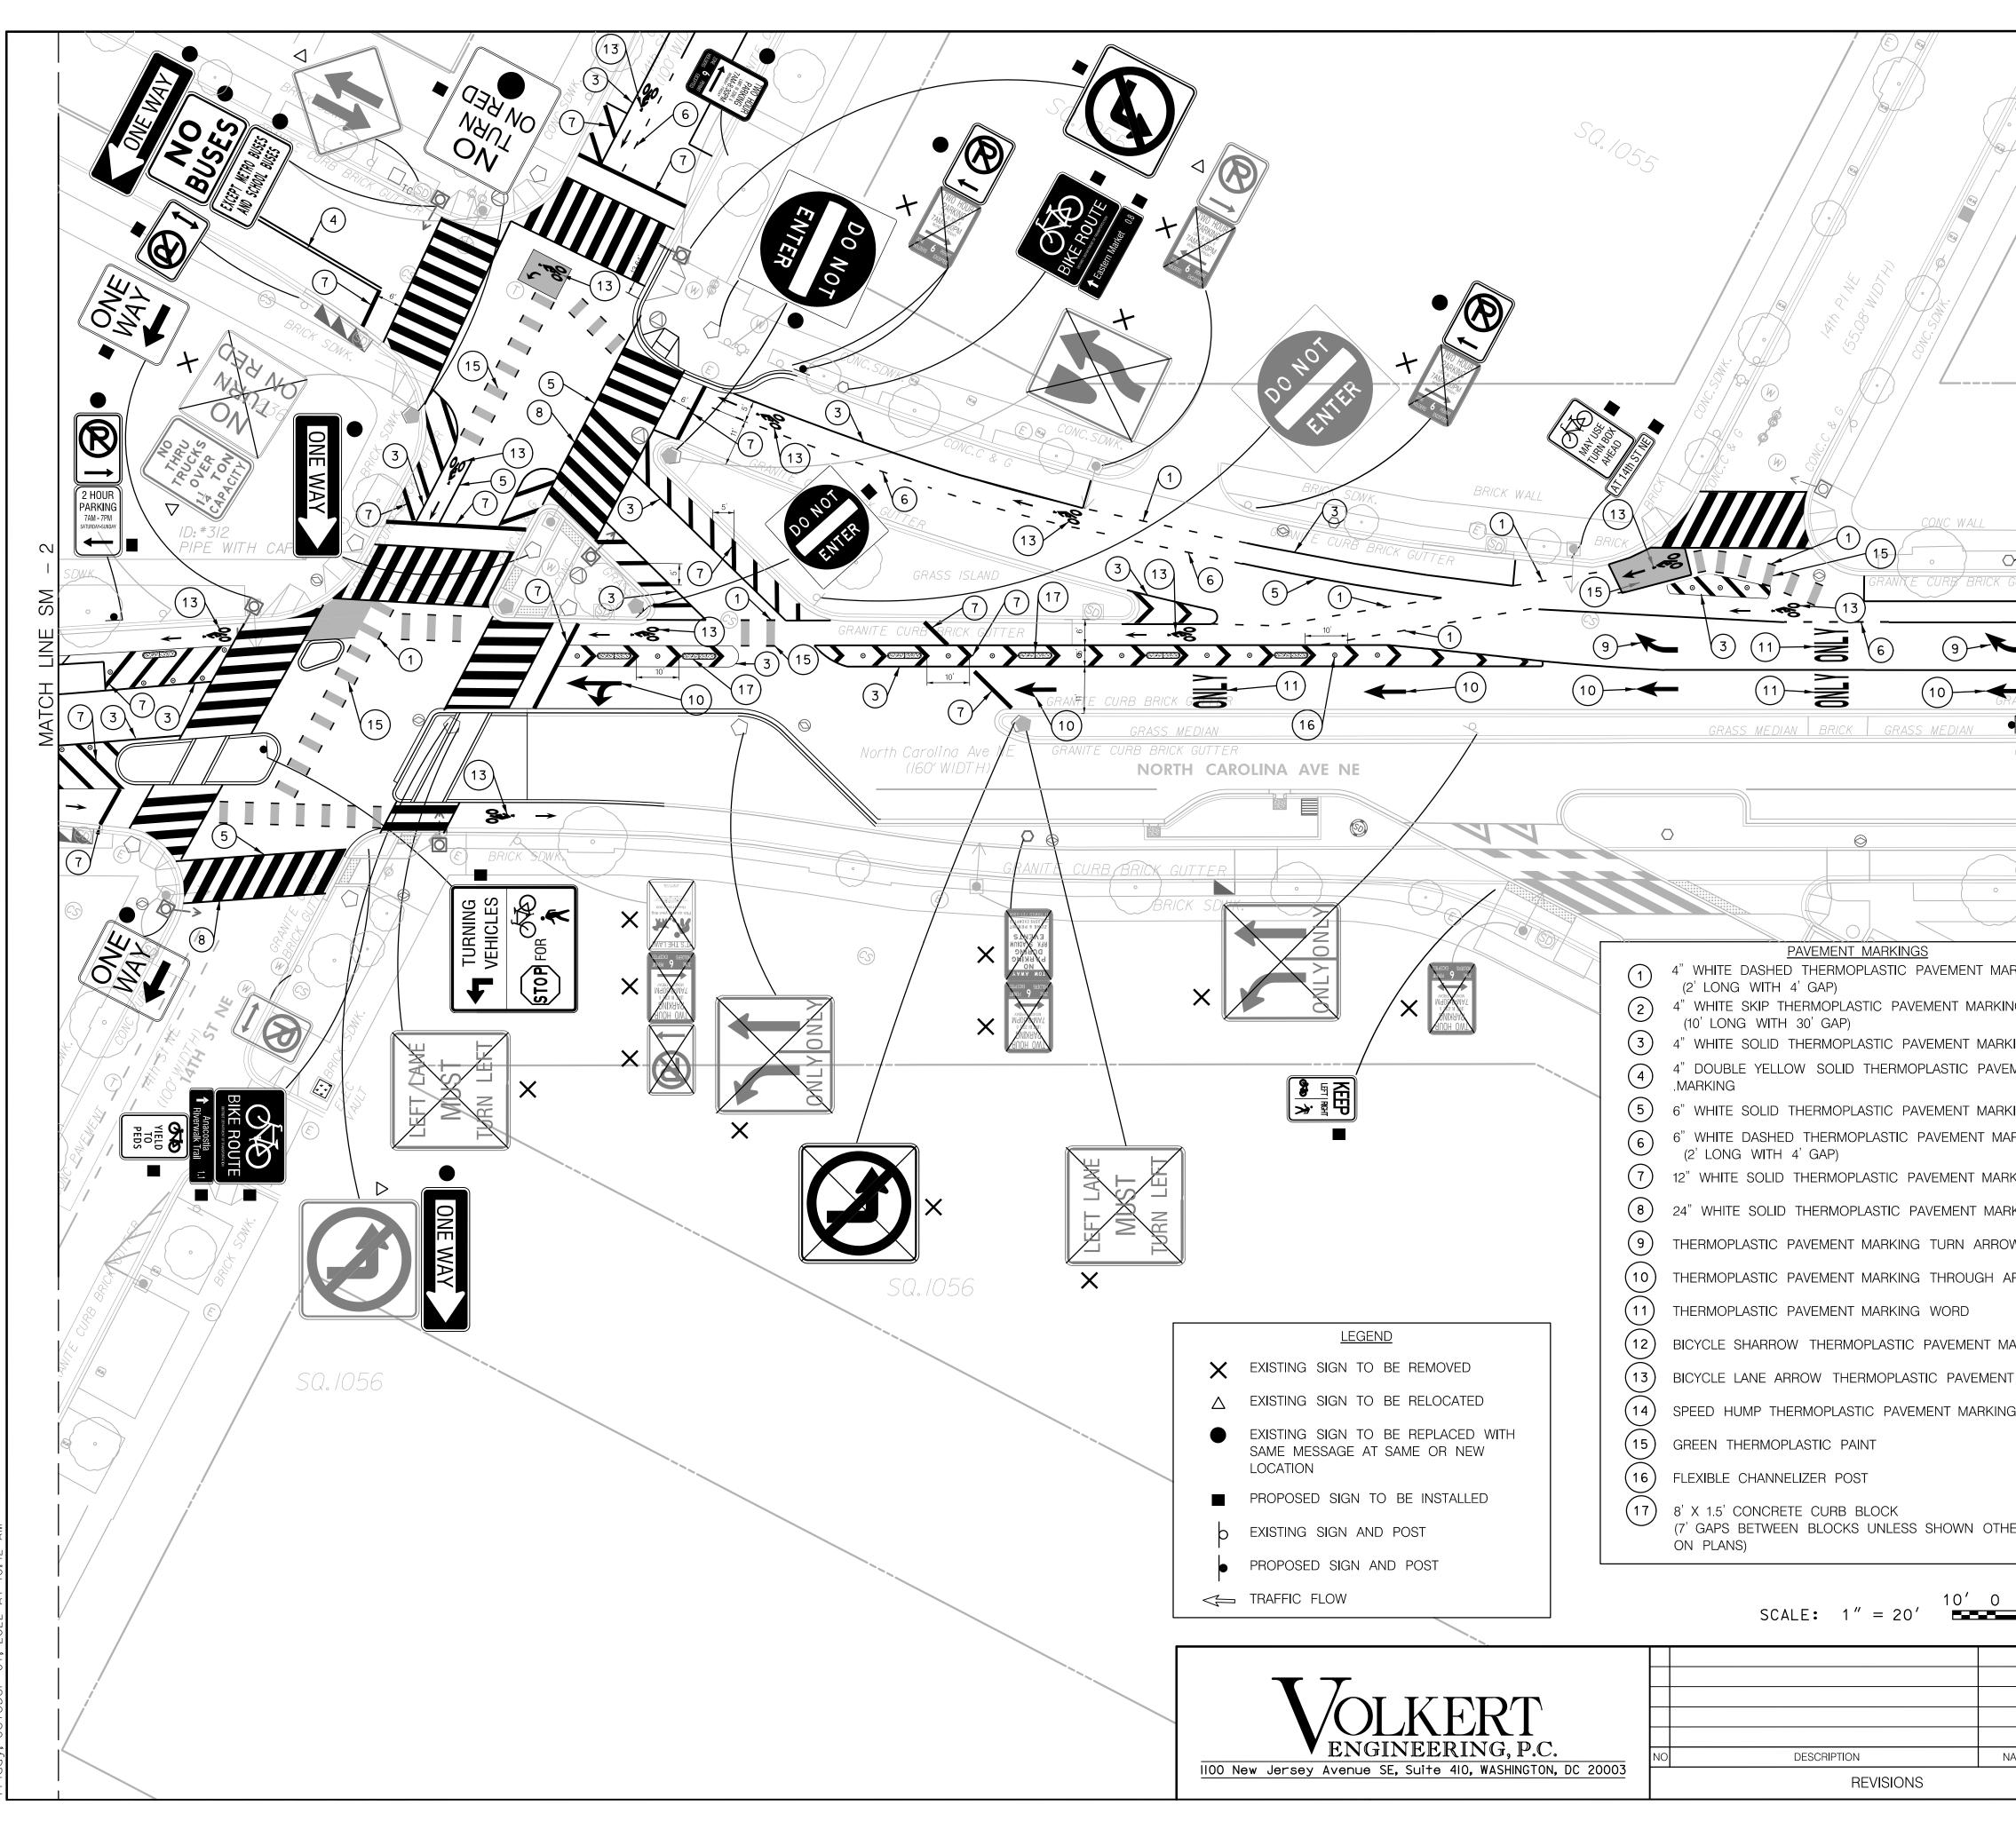
DETOUR FOR ONE-WAY NORTH CAROLINA AVENUE, NE **BETWEEN 13TH STREET, NE** AND 14TH STREET, NE



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	REG	STATE	PROJECT	SHEET NO.	TOTAL SHEETS
	3	D.C.	STP – 2016 (032)	19	32
END 225-2A 25-15*					
STANDARD NOTES: PARKING IS TO BE RESTRICTED 72HRS. IN ADVANCE UNLESS THERE IS AN EMERGENCY.					
AUVANCE UNLESS INFREE IS AN EMERGENCY. SIGNS SHALL BE INSTALLED PRIOR TO THE COMMENCEMENT OF ALL WORK AND REMOVED INMEDIATELY APTER COMPLETION OF ACTIVITIES. IF A SIGN IS NO LONGER REQUIRED IT WILL					
BE REMOVED. SIGNS SHALL BE CONSTRUCTED FROM DURABLE MATERIALS WHICH WILL NOT DETERIORATE UNDER NORMAL AND REPEATED OUTDOOR USE.					
SIGNS SHALL BE MOUNTED ON SPRING LOADED SIGNS TANDS. THE SPACING OF TRAFFIC CONES IS TO BE 10'. IN CASE OF ONE WAY ROADWAY OMIT OPPOSITE SIGNAGE (HAVE SIGNS ON BOTH 75					
OPPOSITE SIGNAGE (HAVE SIGNS ON BOTH SIDES OF ROADWAY APPROACHING WORK 5 AHEAD). 5					
22 ST					
6 020-24 987-118°					
W4-2 45"X48"					
LEFT LANE CLOSED W2D-5 CAHEAD 487X48*					
ROAD WORK AHEAD W20-1 487X46*					
APPROACHING LETT LANE CLOSURE WITH PARKING TCP12 TCP12					
ROAD					
WORK WORK W20-1	NORTH C AVE	AROLINA , NE	M4–1 12" x VARIES"		
AHEAD	DET	OUR	M4–9L 30" × 24"		
			30 X 24		
	(4	4)			
	NORTH AVE	CAROLINA E, NE	M4–1 12" x VARIES"		
DETOUR W20-2	DET	OUR	M4–9		
AHEAD 48" × 48"			30" x 24"		
	(5			
2	N O R T H A V	CAROLINA E, NE	M4–1 12" x VARIES		
	DET	OUR			
NORTH CAROLINA AVE, NE 12" X VARIES			30" × 24"		
R3-1	(6)			
30" × 36"					
AHEAD W16–9P 24" x 12"					
				MT -	9
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NORTH C C STREET NE STF			_ EXTENSION, □	ROJECT ENG. <u>B. B.</u> ESIGNED BY <u>J. S.</u>	
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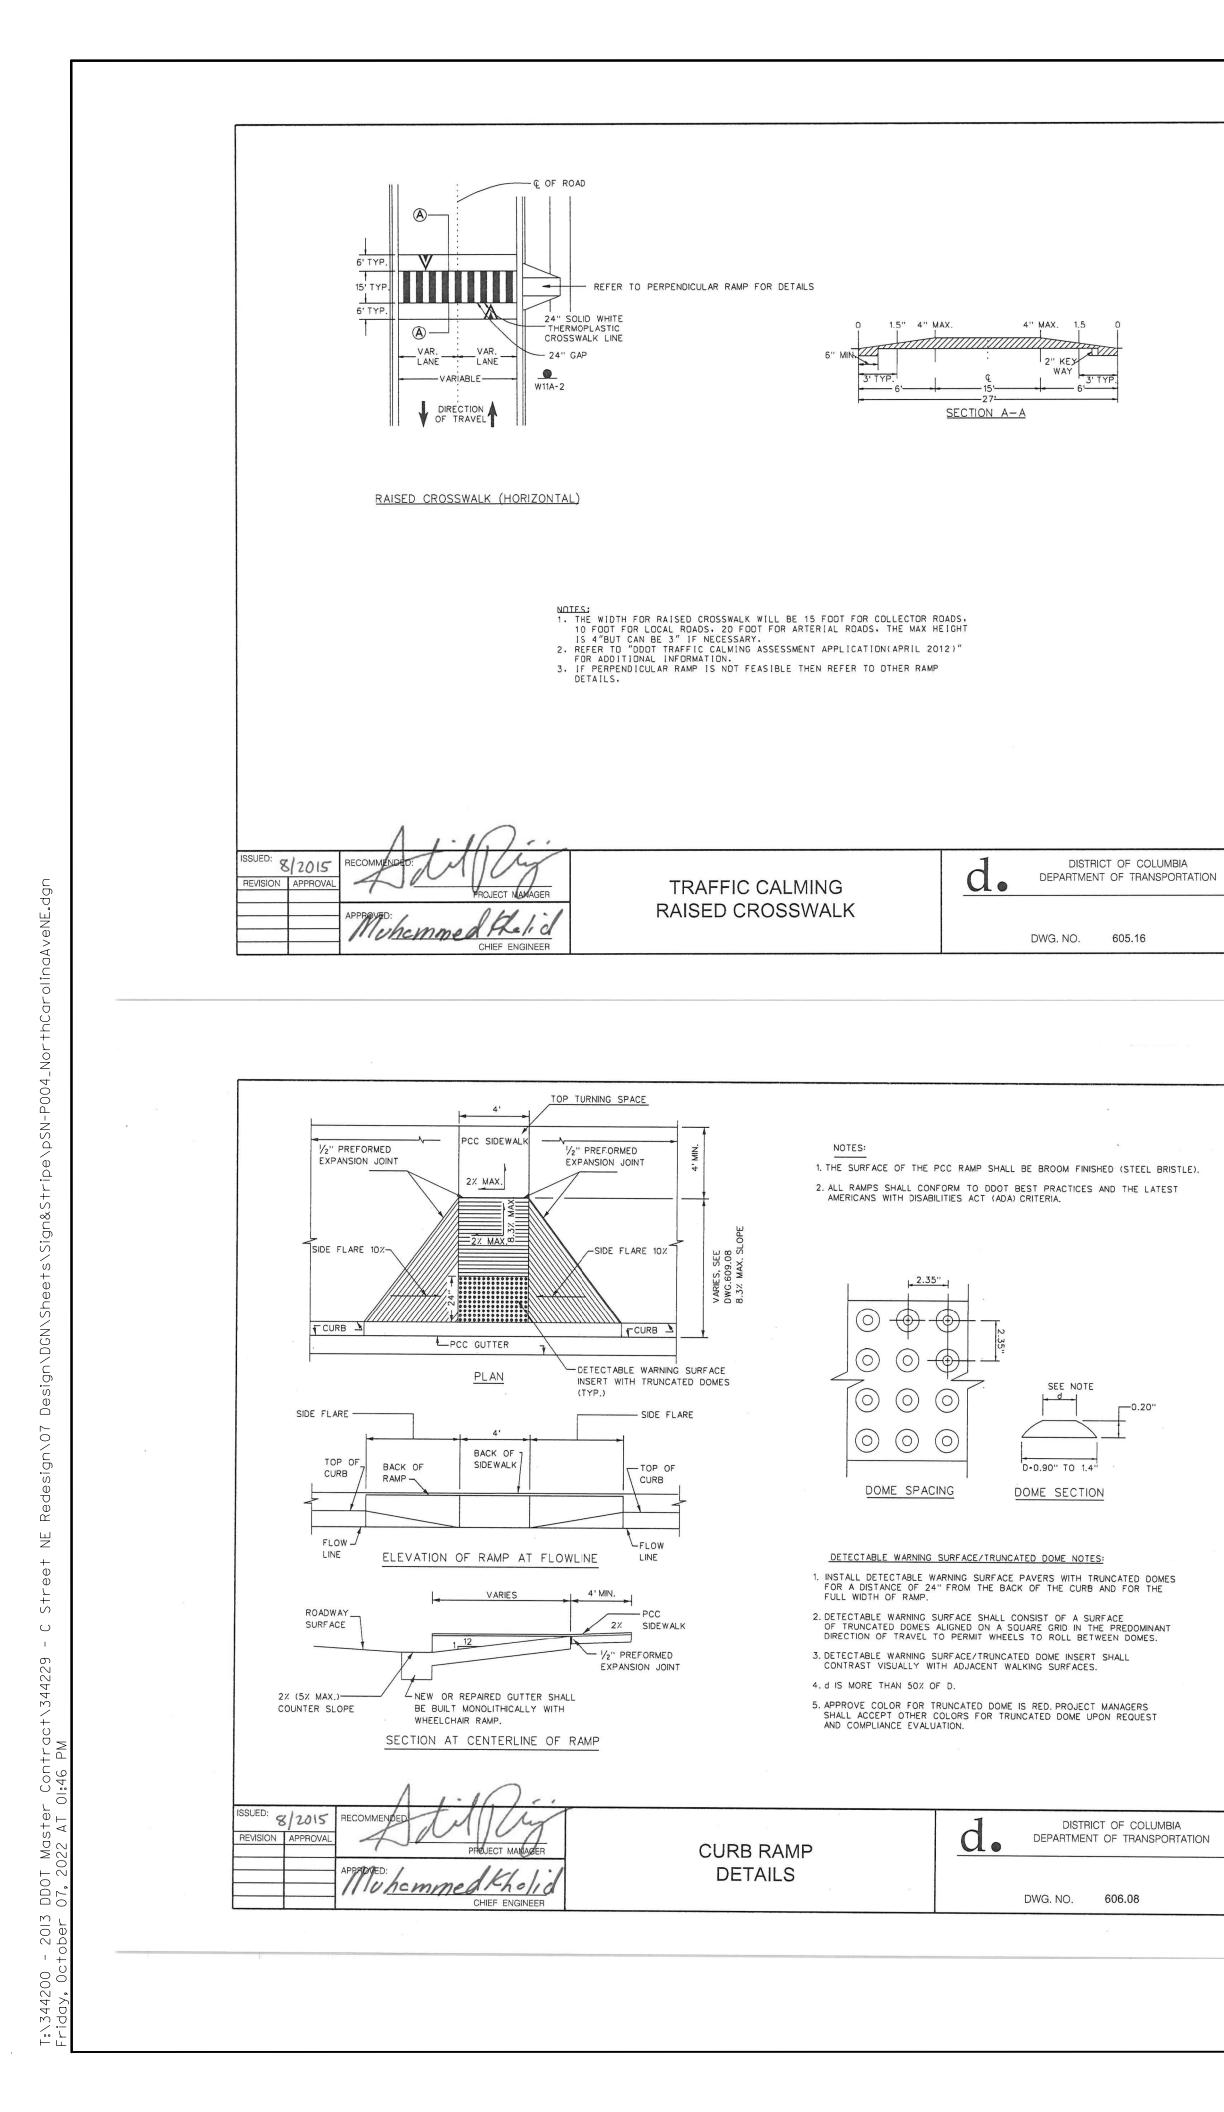






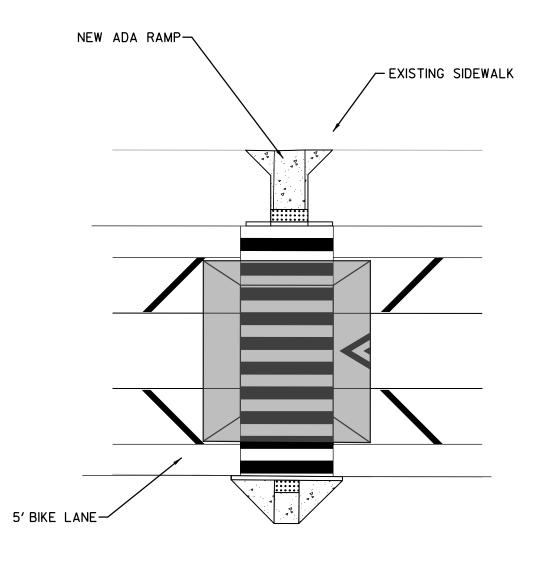
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March S. S.		REG	STATE	PROJECT	SHEET NO.	TOTAL SHEETS
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RANTE CURB BRICK		3	<i>Y</i>		10	-
				GRASS MEDIAN		
GRANITE CURB BR	ICK GUTTER					
	\bigcirc					6
GRANITE CURB BR	ICK GUTTER					
	BRICK SDWK.			BRICK SDW		
	BRICK SDUK.			DATER SOW		0
RKING	SIGNING AND PAVE ALL PAVEMENT MARKINGS A				E	
NG	OTHERWISE NOTED.					
KING	THE CONTRACTOR SHALL S DURING CONSTRUCTION. AN					
EMENT	CONTRACTOR SHALL BE RE EXPENSE.	PLACE	ED AT	CONTRACTOR'S		
KING	TEMPORARY RELOCATION C					A K
ARKING	CONSTRUCTION WILL NOT E ASSOCIATED COST SHALL E	BE DIS	TRIBUT	// //		N S N
RKING	MAINTENANCE OF TRAFFIC			(A) P	12/	
RKING	NEW SIGNS SHALL BE INST THEIR PERMANENT LOCATIC					5 4 0
9W	CONSTRUCTION.				2 El	
ARROW	NEW SIGNS FURNISHED AN WILL BE MEASURED AND P				N.C.	°//
	SALVAGED SIGNS RE-INSTA				G	/
IARKING	MEASURED AND PAID UND					
T MARKING	WMATA.	ιιεlu	UNIEU			
G ARROW	PROPOSED PAVEMENT MAR	KINGS	SHALI	L TIE INTO EXISTING		
	CONTRACTOR SHALL COOR 202.962.6085, WHEN WORK I			· · · · · · · · · · · · · · · · · · ·	SM -	2
		/٦U				J
IERWISE	-			OF TRANSPORTA		
	INFRASTRUCTURE PF					ON
10′20′				GEMENT DIVISION		
	NORTH C C STREET NE STF 13TH ST N	REETSC	CAPE E	EXTENSION, DE	OJECT ENG. <u>B. B.</u> SIGNED BY <u>J. S.</u> IECKED BY <u>H. T.</u>	
	WARD 6 - W			DR	AWN BY <u>M.A</u> OJECT MGR. <u>B.B</u>	<u> </u>
			,		DIVISION CHI	
	SIGNS AND PAVEN				TE	
JAME DATE	NORTH CA	чкΟ	LIINA	FIL	E	
				DW	/G. SM – 3 OF	SM - 5



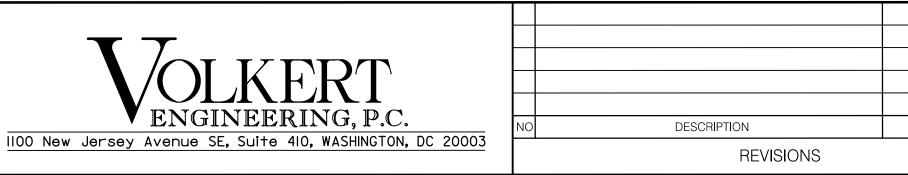
MODIFIED RAISED

RAISED CROSSWALK



<u>PLAN</u>

	PAY ITEM #	612054	612056	612058	612060	612064	612066	612068	612070	612076	616018	616022	616036	600011	600025	612000
DRAWING		THERMOPLASTIC PAVEMENT MARKING, 4 INCH	THERMOPLASTIC PAVEMENT MARKING, 4 INCH DASH	THERMOPLASTIC PAVEMENT MARKING, 6 INCH	THERMOPLASTIC PAVEMENT MARKING, 6 INCH DASH	THERMOPLASTIC PAVEMENT MARKING, 12 INCH	THERMOPLASTIC PAVEMENT MARKING, 24 INCH	THERMOPLASTIC PAVEMENT LETTER	THERMOPLASTIC PAVEMENT ARROW	THERMOPLASTIVE PAVEMENT BICYCLE MARKING, 8 FOOT	METAL SIGN POSTS, 4.00 POUNDS PER FOOT	TRAFFIC SIGN PANELS	REMOVE EXISTING GROUND MOUNTED SIGN	FLEXIBLE CHANNELIZER POST	THERMOPLASTIC GREEN BICYCLE PAINT	8' X 1.5' CONCRETE CURB BLOCK
	UNIT	LF	LF	LF	LF	LF	LF	EA	EA	EA	LF	SF	SF	EA	SF	EA
SM-1		2204	328	797		450	898	8	6	10	60	60	27	17	480	20
SM-2		3124	65	222		270	150		1	8	120	67	23	21	136	61
SM-3	-	1624	562	877	221	541	999	28	11	12	130	85	53	21	698	7
DRAWING TOTAL	-	6952	955	1896	221	1261	2047	36	18	30	310	212	103	59	1314	88
10% CONTINGENCY TOTAL	-	695 7650	96 1050	190 2090	22 240	126 1390	205 2250	4 40	2 20	3 30	31 340	21 230	10 110	6 60	131 1450	9 100



	REG	STATE	PROJECT	SHEET NO.	TOTAL SHEETS
	3	D:C.	STP – 2016 (032) [.]	23	32
CROSSWALK					
CROSSWALK					
	NG SIDE	WALK_			
EXIST:	NG SIDE		\backslash		
NEW ADA RAMP-					
	\mathbf{i}				
5' BIKE LANE/ (BOTH SIDES)	<u> </u>	EW FLI	JSH CURB		
<u>SECTION</u>	<u> </u>				

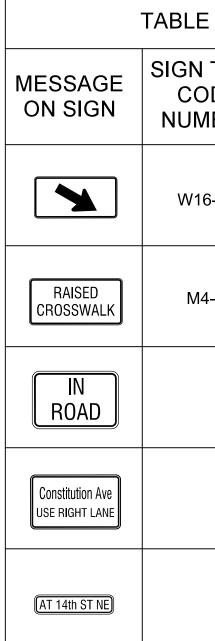
612076	616018	616022	616036	600011	60002
IVE CLE OT	5, 4.00 00T	NELS	ROUND	LIZER	SREEN T

NOTE: SPOT ELEVATION INFORMATION ARE NOT AVAILABLE. GIS WAS USED AS DESIGN BASE PLAN.

			SM - 4
		D.C. DEPARTMENT OF TRANSPORT INFRASTRUCTURE PROJECT MANAGEMENT AD PROJECT MANAGEMENT DIVISIO	MINISTRATION
		NORTH CAROLINA AVE C STREET NE STREETSCAPE EXTENSION, 13TH ST NE TO 14 PL NE WARD 6 – WASHINGTON, D.C.	PROJECT ENG. <u>B. B.</u> DESIGNED BY <u>J. S.</u> CHECKED BY <u>O. B.</u> DRAWN BY <u>W. A.</u> PROJECT MGR. <u>B. B.</u>
IAME	DATE	CROSSWALK DETAIL	DIVISION CHIEF
			FILE

	TABLE OF RE	GULATORY , W	ARNING AND S	PECIAL SIGN	S
MESSAGE ON SIGN	SIGN TYPE CODE NUMBER	NO. OF SIGNS REQUIRED	SIGN SIZE	SQ FT	SQ FT TOTAL
Anacostia Riverwalk Trail 1.1	D1-1B	1	24 in x 6 in	1	1
Eastern Market 0.8	D1-1B	1	24 in x 6 in	1	1
	D11-1	2	24 in x 18 in	3	6
	R3-1	1	30 in x 30 in	6.25	6.25
	R3-2	1	30 in x 30 in	6.25	6.25
EXCEPT METRO BUSES AND SCHOOL BUSES	R3-5g	1	24 in x 12 in	2	2
EXCEPT BICYCLES	R3-7bP	6	30 in x 12 in	2.5	15
DO NOT ENTER	R5-1	4	30 in x 30 in	6.25	25
NO BUSES	R5-4	1	24 in x 18 in	3	3
ONE WAY	R6-1L	5	36 in x 12 in	3	15
ONE WAY	R6-1R	5	36 in x 12 in	3	15
	R6-2L	2	18 in x 24 in	3	6
2 HOUR PARKING 7AM - 7PM SATURDAY-SUNDAY	R7-CUSTOM	4	12 in x 18 in	1.5	6
2 HOUR PARKING 7AM - 7PM SATURDAY-SUNDAY	R7-CUSTOM	4	12 in x 18 in	1.5	6
TWO HOUR PARKING UMIT N ZONE 6 7 AM-8:30PM MODIAN - FROM CONE NO.DEFS 6 PERMIT HOLDEFS 6 PERMIT	R7-CUSTOM	7	12 in x 18 in	1.5	10.5
	R7-CUSTOM	6	12 in x 18 in	1.5	9
TWO HOUR PARKING LIATIN ROTES 7AM-8:30PPM MORDAR-FRANKT COILE COILE COILE BOCEPTED	R7-CUSTOM	2	12 in x 18 in	1.5	3
	R7-1	7	12 in x 18 in	1.5	10.5

TABLE OF REGULATORY, WARNING AND SPECIAL SIGNS										
MESSAGE ON SIGN	SIGN TYPE CODE NUMBER	NO. OF SIGNS REQUIRED	SIGN SIZE	SQ FT	SQ FT TOTAL					
	R7-1	5	12 in x 18 in	1.5	7.5					
	R7-1	3	12 in x 18 in	1.5	4.5					
TOW AWAY RESERVED PARKING Special premit Number #### IP TOWED 727-5005	R7-8	1	12 in x 18 in	1.5	1.5					
TOW AWAY RESERVED PARKING ES special permit number #### 15 Towed 727-5000	R7-8	1	12 in x 18 in	1.5	1.5					
MAY USE TURN BOX AHEAD	R9-CUSTOM	1	12 in x 18 in	1.5	1.5					
YIELD TO PEDS	R9-6	1	12 in x 18 in	1.5	1.5					
	R9-7	1	12 in x 18 in	1.5	1.5					
NO TURN ON RED	R10-11a	1	24 in x 30 in	5	5					
TURNING VEHICLES	R3-2	1	30 in x 30 in	6.25	6.25					
	W11-1	1	30 in x 30 in	6.25	6.25					
	W11-2	1	30 in x 30 in	6.25	6.25					
(A)	W11-2	1	30 in x 30 in	6.25	6.25					
	W16-7P	1	24 in x 12 in	2	2					



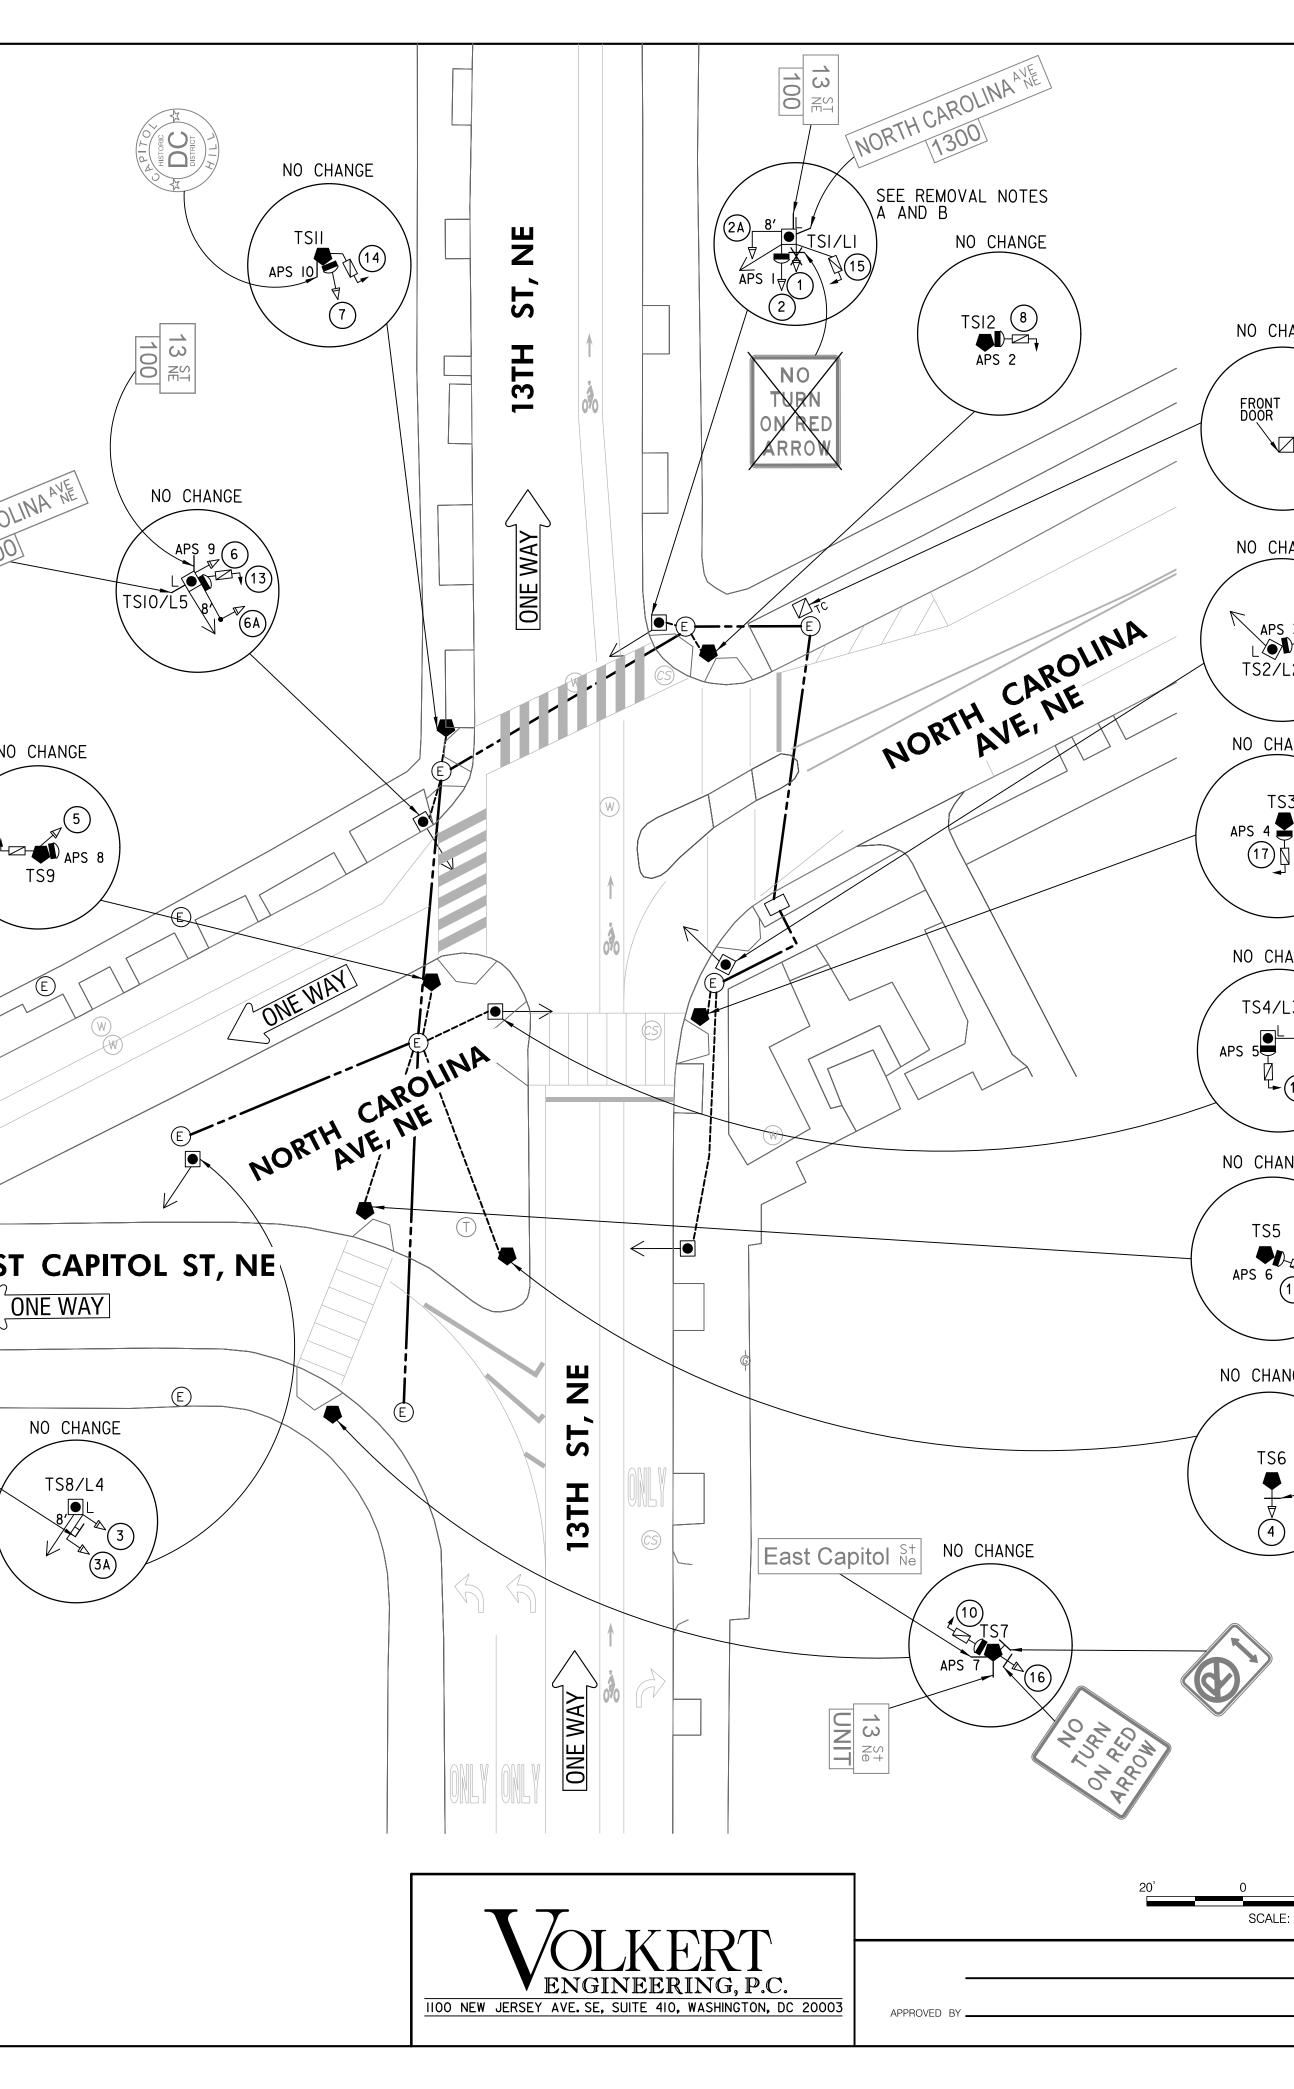


2					SM - 5
				D.C. DEPARTMENT OF TRANSPOR INFRASTRUCTURE PROJECT MANAGEMENT AD PROJECT MANAGEMENT DIVISI	OMINISTRATION
				NORTH CAROLINA AVE C STREET NE STREETSCAPE EXTENSION, 13TH ST NE TO 14 PL NE WARD 6 – WASHINGTON, D.C.	PROJECT ENG. <u>B. B.</u> DESIGNED BY <u>J. S.</u> CHECKED BY <u>O. B.</u> DRAWN BY <u>M. A.</u> PROJECT MGR. <u>B. B.</u>
NO	DESCRIPTION	NAME	DATE	PERMANENT SIGN SCHEDULE	DIVISION CHIEF
	REVISIONS				DWG. SM - 5 OF SM - 5

REG	STATE	PROJECT	SHEET NO.	TOTAL SHEETS
3	D.C.	STP - 2016 (032)	24	32

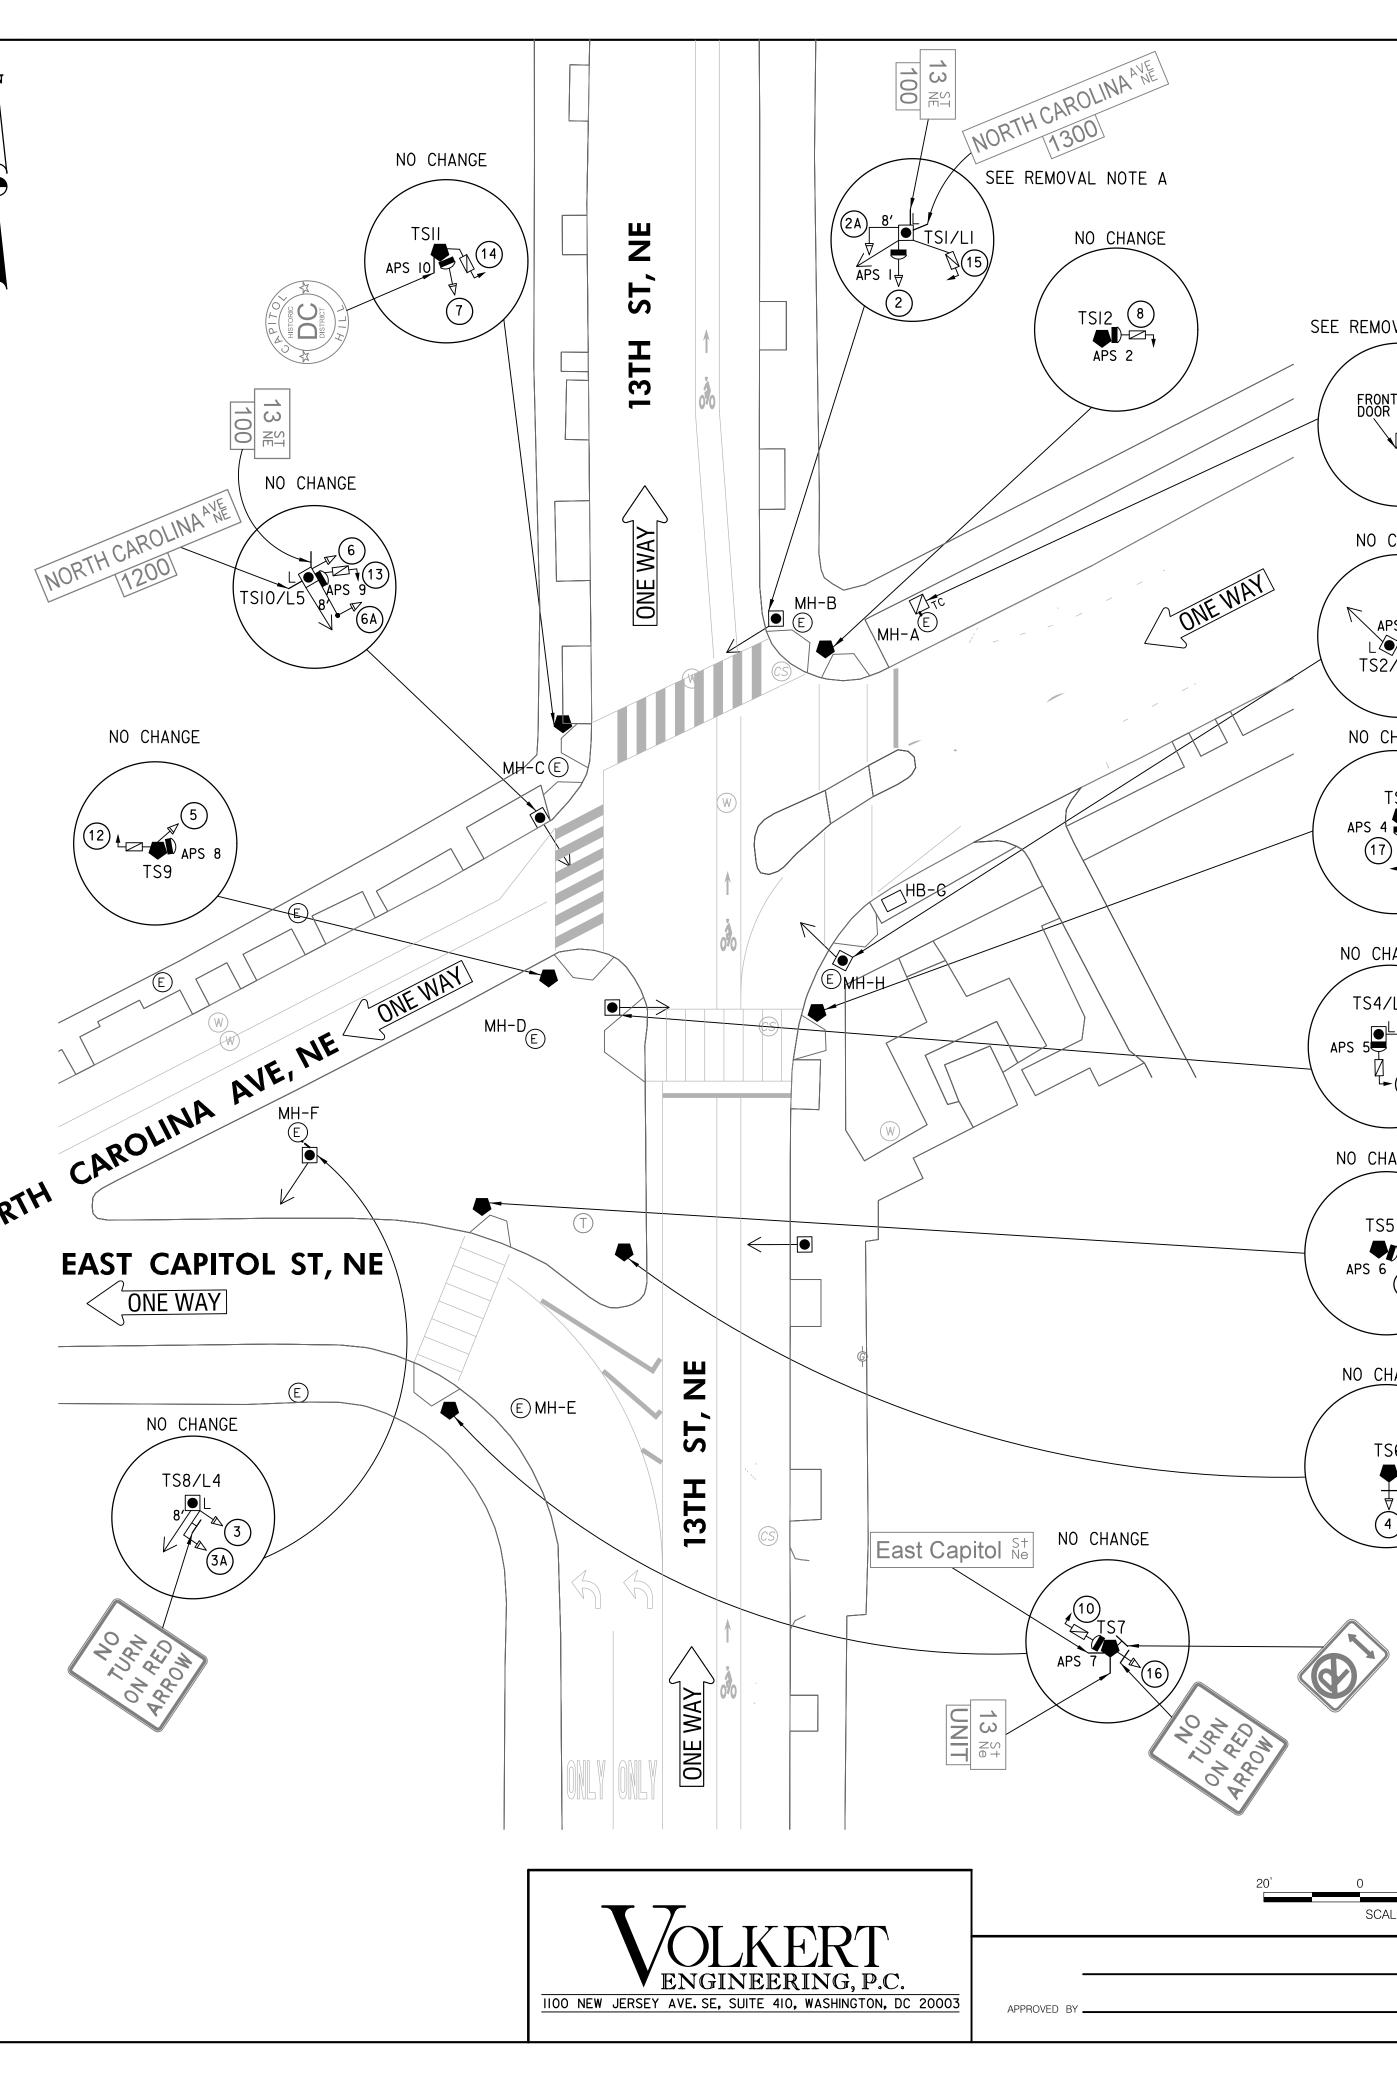
E OF REGULATORY , WARNING AND SPECIAL SIGNS								
N TYPE ODE MBER	NO. OF SIGNS REQUIRED	SIGN SIZE	SQ FT	SQ FT TOTAL				
16-7P	1	24 in x 12 in	2	2				
14-1	2	24 in x 12 in	2	4				
	1	24 in x 12 in	2	2				
	2	24 in x 12 in	2	4				
	1	24 in x 12 in	2	2				

		REVIS	1	CLIK						N	
Τ	DESCRIPTION	DATE	COR.	СНК.	APP.	APP.	APP.	APP.	APP.		
										•	
GEN	NERAL NOTES:		•								
Α.	ALL WORK RELATING T SIGNALS SHALL CONFO	O THE INS RM WITH A	· · · — — · ·		- · · · ·						
	OF THE LATEST VERSI		OT ST	ANDAR		CIFIC					
B.		FURNISHE		INST		• WR	S FOR ITTEN				
с.	APPROVAL FROM DDOT PROCUREMENT. THE CONTRACTOR SHAL						FABLE	•			
	CONCRETE BASES, TRA PEDESTRIAN SIGNAL H										
D.	MOUNTING HARDWARE. THE CONTRACTOR SHAL SIGNAL EQUIPMENT TO			EMOVE AL SH			СТ			NOP	THU
F	MR. RANDOLPH COOPER AT 202-905-6059 TO	ARRANGE S	ERVIC								
E.	IF THE EXISTING PEP CONTRACTOR SHALL CO AND PAY FEES.										
F.	THE CONTRACTOR SHAL POLES TO TEMPORARY					EXIS	FING				
G.	OTHERWISE ON PLAN. NO ABOVE GROUND HAR A MINIMUM 4' CONTIN	DWARE WIL UOUS PATH	L BE I FOR /	PLACE ADA P	D SUC URPOS	H THA	AT 5 NOT				
Η.	MAINTAINED. ALL TEMPORARY POLES DDOT SIGNAL TECHNIC										/
Ι.	UNLESS POLES ARE PR THE CONTRACTOR IS R	OPERLY GR ESPONSIBL	OUNDEI E FOR	D. Main	ΤΑΙΝΙ	NG PF	ROPER				
J.	ALIGNMENT AND OPERA POLES. NO TEMPORARY CABLES						≺ARY				
0.	TEMPORARY CABLING S FLEX CONDUIT AND SH	HALL BE PI ALL BE AC	ROPERI CESSII	LY EN BLE S	CLOSE	DIN					
Κ.	EMERGENCY REPLACEME THE CONTRACTOR SHAL RESTORATION OF ALL	L BE RESP	ONSIBI	LE FO							
	CURBS, SIDEWALKS, L CONSTRUCTION AND AT	ANDSCAPIN THE END	G IRR OF COI	IGATI NSTRU	ON AR CTION	EAS [•	DURIN	G			/
L. M.	THE CONTRACTOR SHAL ITEMS AS SHOWN ON T NO CHANGES FROM PLA	HE APPROVI	ED TRA	AFFIC	SIGN	IAL PL	ANS.	SIGN	IAL		15
141 •	STRUCTURES, SIGNAL EQUIPMENT WILL BE A	HEAD PLAC LLOWED WI	EMENT THOUT	OR T PRIO	RAFFI R APP	C SIC ROVAL	GNAL OF				
CAR	DISTRICT DEPARTMENT	OF TRANS	PORTA	TION,	TRAF	FIC S	SIGNA	L DIV	ISION	Ν.	/
1.	DDOT PERSONNEL WILL										
	INSIDE THE CONTROLL MAKE ALL ELECTRICAL PEDESTRIAN SIGNAL H	CONNECTIO					IALL				_
2.	TEMPORARY SIGNAL CA SURFACE SHALL BE PR	BLES EXTEN					1D				E
3.	CONDUIT. THE CONTRACTOR SHAL COILED NEATLY AT EA										<
	BASE.			UNTA		oonor					
	MOVAL NOTES:				4					2 2 2	No.
А. В.	COVER EXISTING TRAF REMOVE EXISTING TRA					WN ON	PLAN	۱.		A CO	
										~	

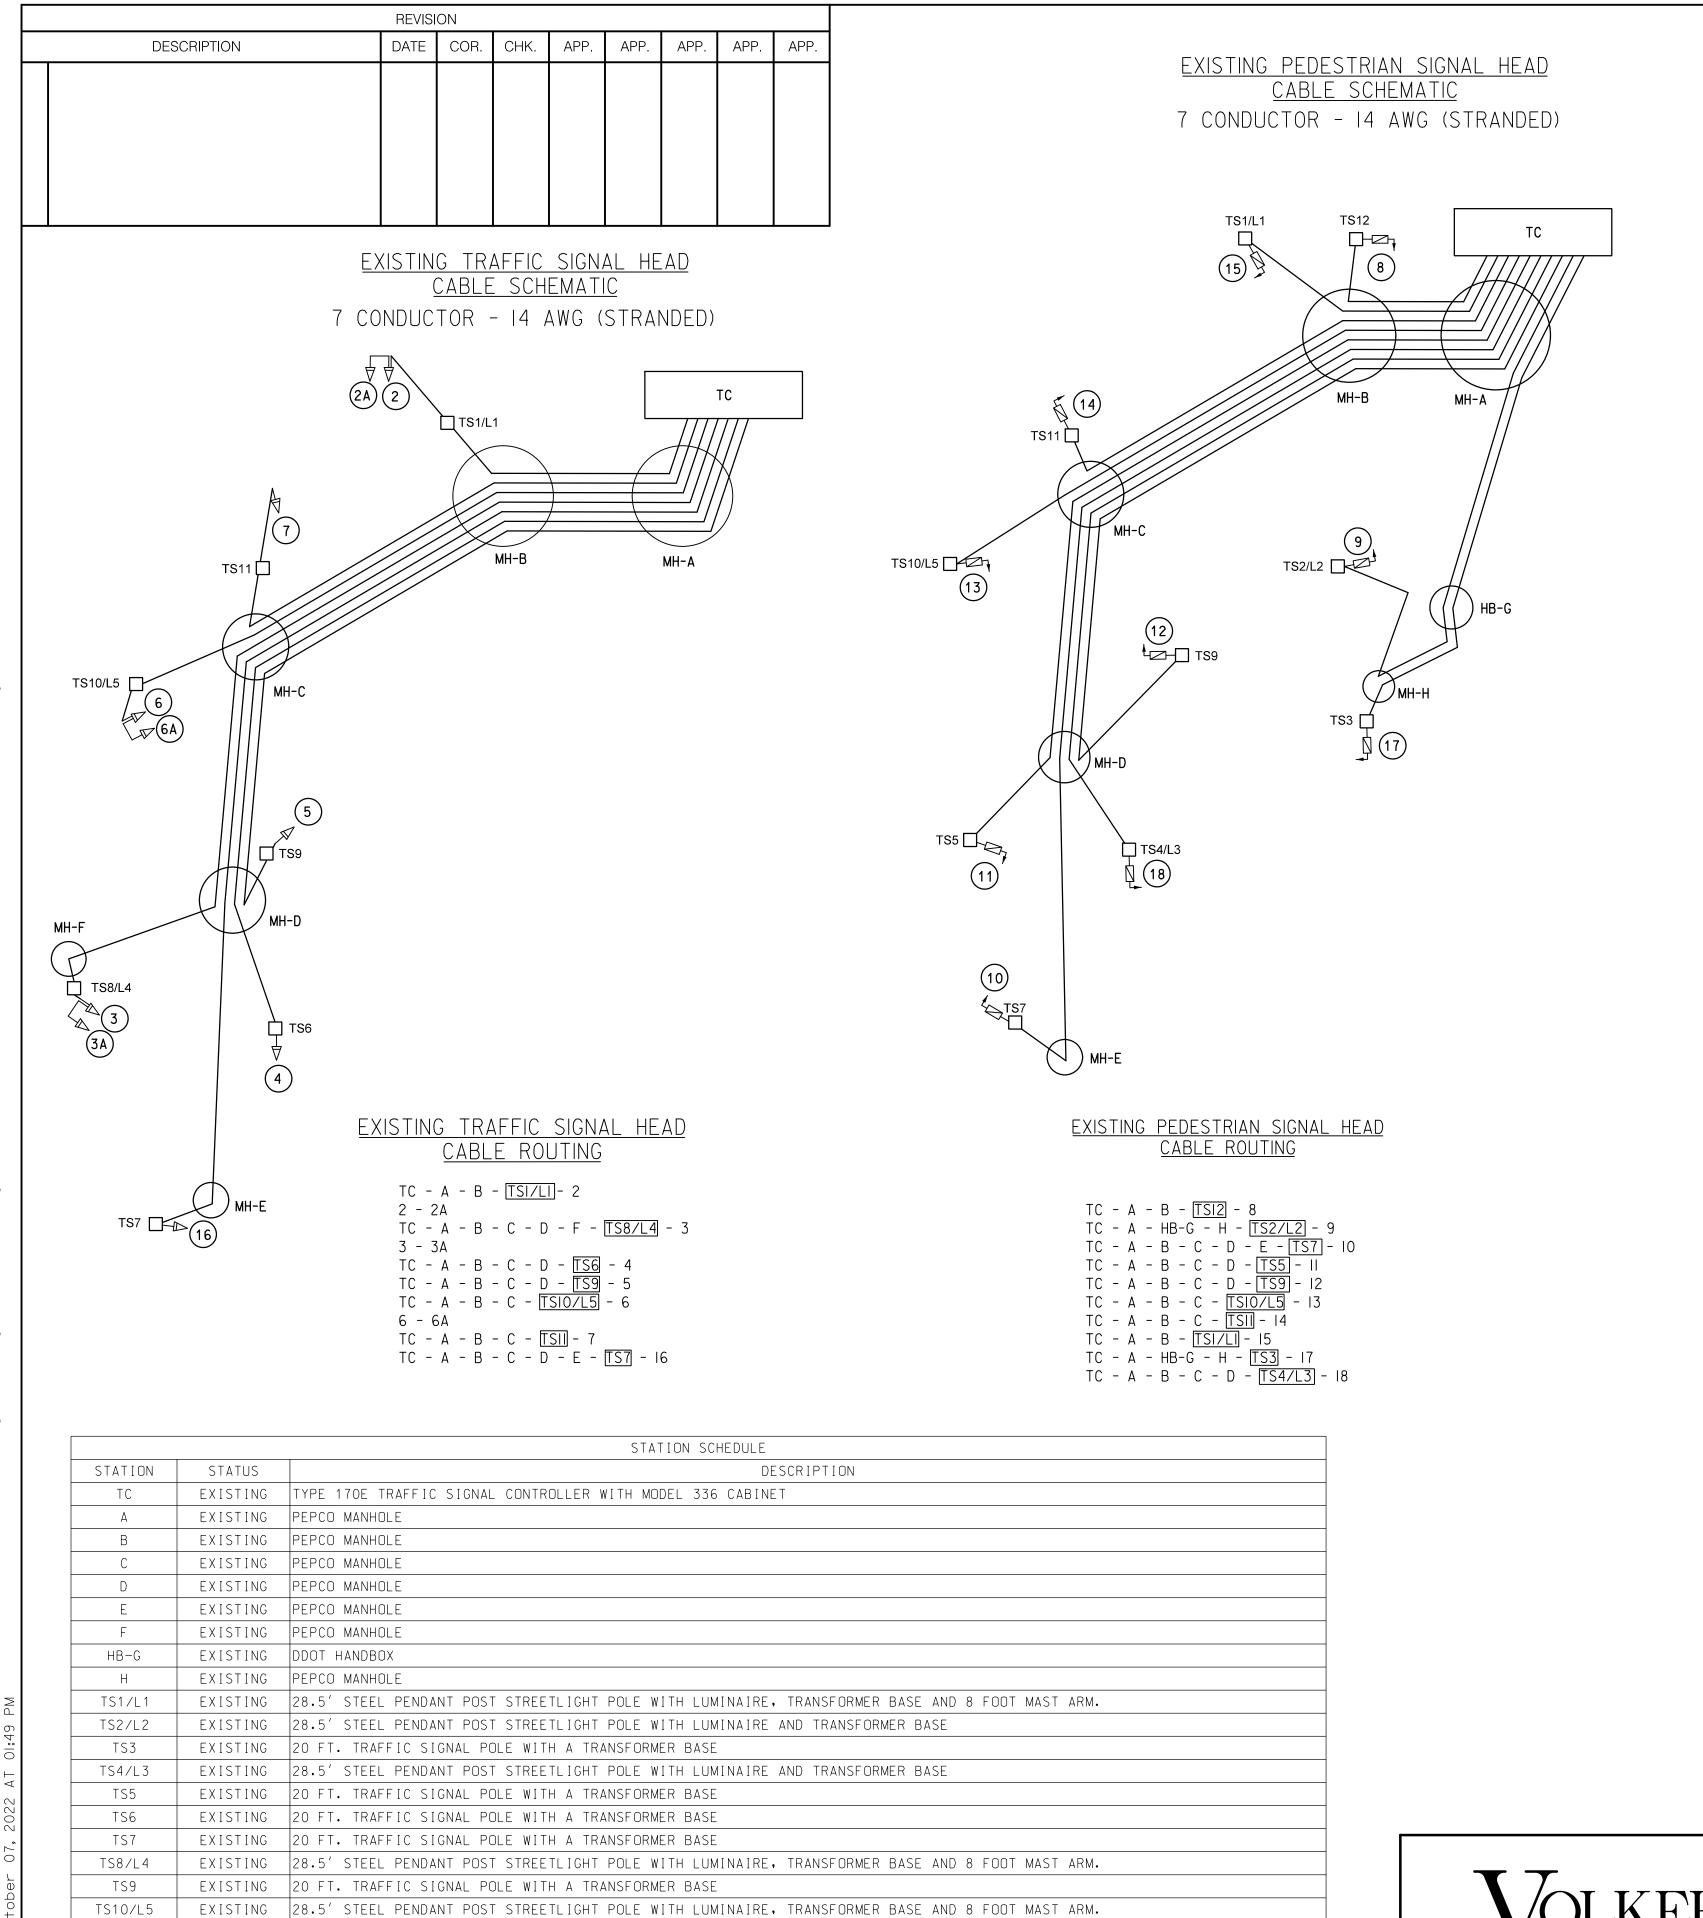


			REG	STATE	PROJECT		SHEET NO.	TOTAL SHEETS
			3	D.C.	STP – 2016	(032)	25	32
CHANGE	 ✓ EXIST MODE ● EXIST BASE ● EXIST WITH ● EXIST (ALL ● EX	L 336SS ING 20-FO ING 28.5- LUMINAIRE ING 8-FOO ING 3-SEO LENSES I ING 2-SEO LENSES I ING ACCES ING LUMIN IGHT ING SIGN ING WHEE ING GAS	3 ITOE CABIN OOT T FOOT E AND OT MA CTION 2") CTION 2") SSIBLE NAIRE INED S R MAN MANHO PHONE TRICAL	D.C. TRAF ET AN RAFFI PEND A TF AST A LED LED E PED AND S R RAM SANITA NHOLE DLE MANI	STP - 2016 FIC SIGNAL CONTIND EXTERNAL UPS C SIGNAL POLE W ANT POST STREE RANSFORMER BASE RM WITH CAP ANI TRAFFIC SIGNAL H COUNT-DOWN PED ESTRIAN SIGNAL (SUPPORT ARM IND IP ARY MANHOLE HOLE	ROLLER WITH S SYSTEM ITH TRANSF TLIGHT POL CLAMP EAD CONVE ESTRIAN SIG APS) PUSH E	NO. 25 H A ORMER E NTIONA NAL HE	SHEETS 32 L
ANGE								
56 NO TURN ON RED ARROW							SG	- 1 ISA
	SEQUENCE	E OF OPEF		I DRA	WING NO. TS 1603	-С		28
		ARTMEI	NT (OF ⁻	COLUMBIA	ATION	STA FIELD CHE	GE 1 :cked by K
	10	NORT	Н СА	ROLIN	CAPITOL STREET, A NA AVENUE, N.E. MODIFICATION	AND	DRAWN B	S r IA
<u>20'</u> 40'	SUBMITTED:	TRAFFIC SIGNAL	L PROJEC	T ENGINEE	ĒR	DATE	H Date IO/	
LE: 1" = 20'		TRAFFIC SIGNAL	L DESIGN	PROJECT	MANAGER	DATE		20′
DATE	APPROVED	ITS / TRAFF			IANCE DIVISION MANAGER	DATE	SHEET I DRAWING S-21	OF 1 NO. 26-B
··		JULI I U JUNA		WANA		DATE		0

	DESCRIPTION	DATE	COR.	CHK.	APP.	APP.	APP.	APP.	APP.	N
G	ENERAL NOTES:		<u> </u>				<u> </u>	<u> </u>		
	L WORK RELATING TO TH									
VE	RSIONS OF DDOT STANDA	RD DRAWI	NGS, S							
B.TH	E CONTRACTOR SHALL SI UIPMENT AND MATERIALS	JBMIT TO	DDOT				ALL			
PF	NITTEN APPROVAL FROM I OCUREMENT.									
TH	E LOCATION OF PROPOSE E LOCATION OF ALL PRO	POSED EQ	UIPMEN	NT AND) MATE	RIALS	TE			
EN	ALL BE FIELD LOCATED, GINEER PRIOR TO INSTAL E CONTRACTOR SHALL FI	LATION.)			
CC	NDUITS, MANHOLES, POLE BINET FOUNDATION.						,			
PE	E CONTRACTOR SHALL FU DESTRIAN SIGNAL HEADS,	TRAFFIC	SIGNAL	POLE	S, TRA	NSFOR	MER			
AL	SES, APS UNITS, TRAFFIC L MOUNTING HARDWARE.									
PC	E CONTRACTOR SHALL RI LES, CONTROLLER AND H RTABLE, CONCRETE BASE	ARDWARE	MOUNT	ED ON	Ι ΤΕΜΡ	ORARY	9			
PC	LE (IF ANY) AND THE PED DUNTED ON IT.									
PC	E CONTRACTOR SHALL RI RTABLE, CONCRETE BASE	S.				·				
EC	E CONTRACTOR SHALL RI UIPMENT TO DDOT TRAFF	FIC SIGNAL	SHOP	, CONT	ACT N	IR. RAN	IDOLPH			
SE	PPER 72 HOURS IN ADVA RVICE. ABOVE GROUND HARDWA									
SL	CH THAT A 4 FEET CLEARPOSES.									
SH	NEW PEPCO ELECTRICAL ALL COORDINATE SERVICE	E INSTALL	ATION	AND P	AYMEN			0		
	ACCORDANCE WITH CONTR		CIAL P	RUVISI	JNS.					
	BACK PLATE SHALL BE		O EAC	h mas ⁻	Т					
B. T⊦	M MOUNTED SIGNAL HEAD E BOTTOM OF MAST ARM	MOUNTE								51
C. EX	ALL BE 16 FEET ABOVE ISTING SIGNAL HEADS 2A, DUNTED WITH AN ASTRO-E	, 3A AND	6A AF	RE	E.					NORT
	UIVALENT.	SNAC ON A	AF F NUY	νED						
С	ABLE NOTES:									
	OT PERSONNEL WILL MAK SIDE THE CONTROLLER CA						KF			
AL	L ELECTRICAL CONNECTION SNAL HEADS.									
B.TH 7C	E CONTRACTOR SHALL FU				-					
C.TH	GNAL HEADS. E CONTRACTOR SHALL FU				-		-			
OF	IELDED 4C I8AWG STRANI 4C I8AWG SHIELDED, ST CH POLE MOUNTED APS	RANDED C	ABLE	SHALL	EXTEN	ID FRO	М	_IN		
SIC D. TH	GNAL HEAD MOUNTED ON E CONTRACTOR SHALL FI	THE SAME JRNISH AN	: POLE D INST							
FIE	BER OPTIC COMMUNICATION	N CABLES.								
R	EMOVAL NOTES:									
B. RE	MOVE SIGNAL HEAD NO.IA MOVE ASSOCIATED WIRING	CONNECTIO	N FOR							
NC	. I IN EXISTING CONTROLLE	R CABINET.								



							0.1557	TOTAL
			REG	STATE	PROJECT	(000)	SHEET NO.	TOTAL SHEETS
			3	D.C.	STP – 2016	(U32)	26	32
		LEGEND:						
	TC				FIC SIGNAL CONT		ΉA	
		EXISTING 20-F BASE	T TOO	FRAFFI	IC SIGNAL POLE W	/ITH TRANSF	FORMER	
	L	EXISTING 28.5			ANT POST STREE		.E	
OVAL NOTE B	<u>8′</u>				RANSFORMER BASE RM WITH CAP ANI	_		
		EXISTING 3-SE (ALL LENSES		LED	TRAFFIC SIGNAL H	IEAD CONVE	ENTIONA	L
INT IR	-27	EXISTING 2-SE	CTION	LED	COUNT-DOWN PED	ESTRIAN SIG	GNAL HI	EAD
		(ALL LENSES EXISTING ACCE		E PED	ESTRIAN SIGNAL (APS) PUSH	BUTTON	١
	\rightarrow	OF LIGHT		AND S	SUPPORT ARM IND	DICATES DIR	ECTION	
CHANGE	q	EXISTING SIGN EXISTING WHEE		r ram	1P			
(9)	¢ (CS)	EXISTING GAS						
APS 3	(IS) (IV)	EXISTING COME EXISTING WATE						
2/L2	G	EXISTING GAS EXISTING TELE			HOI F			
	(T) (E)	EXISTING ELEC	CTRICA					
CHANGE		EXISTING HANE						
T <u>S</u> 3	R.O.W.	RIGHT OF WAY						
	(Canal Party)	PROPOSED 8'	X I.5′	CONCR	RETE CURB BLOCK			
	O	PROPOSED FLE	EXIBLE	CHAN	INELIZER POST			
HANGE								
/L3								
- (18)								
HANGE								
CHANGE								
	IO JRN							
ON	RED ROW							
	ROW						SG	2
-								- Z ISA
	SEC	QUENCE OF OPE		N DRA	WING NO. TS 1603	–D		228
							FIN	VAL
					AND SIGNALS DIV		FIELD CHI	ECKED BY
					CAPITOL STREET, A		F DESIGNED	РК
		NOR	ТН СА	ROLIN	A AVENUE, N.E. MODIFICATION		DRAWN B	
							REVIEWED) BY
	SUB	MITTED: TRAFFIC SIGNA	AL PROJEC	T ENGINEE	ER	DATE	- DATE	HT
	40'							/22
CALE: 1" = 20'		TRAFFIC SIGNA	AL DESIGN	PROJECT	MANAGER	DATE	- SCALE	= 20'
	-	ITS / TRAF	FIC SIGNAI	L MAINTEN	NANCE DIVISION MANAGER	DATE	- SHEET	OF 3
DATE	APF	ROVED TRAFFIC SIGN	NAL PROGR		GER	DATE	- DRAWING S-21	NO. 126-С
						=		



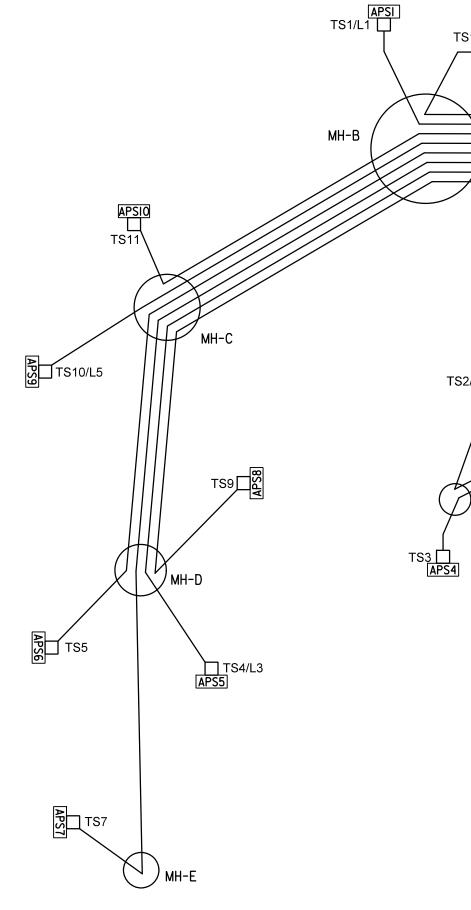
TS11

TS12

EXISTING 20 FT. TRAFFIC SIGNAL POLE WITH A TRANSFORMER BASE

EXISTING 20 FT. TRAFFIC SIGNAL POLE WITH A TRANSFORMER BASE





EXISTING ACCESSIBLE PEDESTRIAN SIGNAL (APS) CABLE ROUTING

TC - A - B - <u>TSI/LI</u> - APS-I - 15
TC - A - B - <u>TSI2</u> - APS-2 - 8
TC - A - HB-G - H - <u>TS2/L2</u> - APS-3 - 9
TC - A - HB-G - H - <u>TS3</u> - APS-4 - 17
TC - A - B - C - D - <u>TS4/L3</u> - APS-5 - 18
TC - A - B - C - D - <u>TS5</u> - APS-6 - II
TC - A - B - C - D - E - TS7 - APS-7 - IO
TC - A - B - C - D - <u>TS9</u> - APS-8 - 12
TC - A - B - C - <u>TSIO/L5</u> - APS-9 - 13
TC - A - B - C - TSII - APS-IO - I4



APPROVED BY

DATE

	REG	STATE	PROJECT	SHEET NO.	TOTAL SHEETS
ESTRIAN SIGNAL (APS),	3	D.C.	STP – 2016 (032)	27	32
WG (STRANDED)					
			STING STREETLIGHT		
		<u> </u>	ABLE SCHEMATIC		
			MH-D		
MH-A			2.#10		
			₩ TS4/L3		
		ΕX	ISTING_STREETLIGHT		
			D - TS4/L3		
HB-G					
Умн-н					

CONDUIT SUMMARY									
LOCATION TO LOCATION	STATUS	SIZE (DIA.) (IN)	NUMBER OF CONDUITS	QUANTITY (FT)					
TC – A	EXISTING	2,4	2,2	5					
A – B	EXISTING	4	1	25					
A – HBX	EXISTING	2	4	55					
B – C	EXISTING	*EXISTING	*EXISTING	60					
B - TS1/L1	EXISTING	*EXISTING	*EXISTING	5					
B - TS12	EXISTING	2,4	1,1	10					
C - TS10/L5	EXISTING	*EXISTING	*EXISTING	10					
C - TS11	EXISTING	4	1	10					
C – D	EXISTING	*EXISTING	*EXISTING	55					
D - TS9	EXISTING	4	1	15					
D - TS4/L3	EXISTING	2,4	1,1	15					
D - TS5	EXISTING	2,4	1,1	35					
D - TS6	EXISTING	4	1	50					
D – E	EXISTING	*EXISTING	*EXISTING	75					
D - F	EXISTING	4	1	55					
E – TS7	EXISTING	4	1	15					
F - TS8/L4	EXISTING	*EXISTING	*EXISTING	5					
HB-G - TS2/L2	EXISTING	*EXISTING	*EXISTING	5					
H – HB–G	EXISTING	*EXISTING	*EXISTING	25					
H - TS3	EXISTING	2,4	1,1	10					

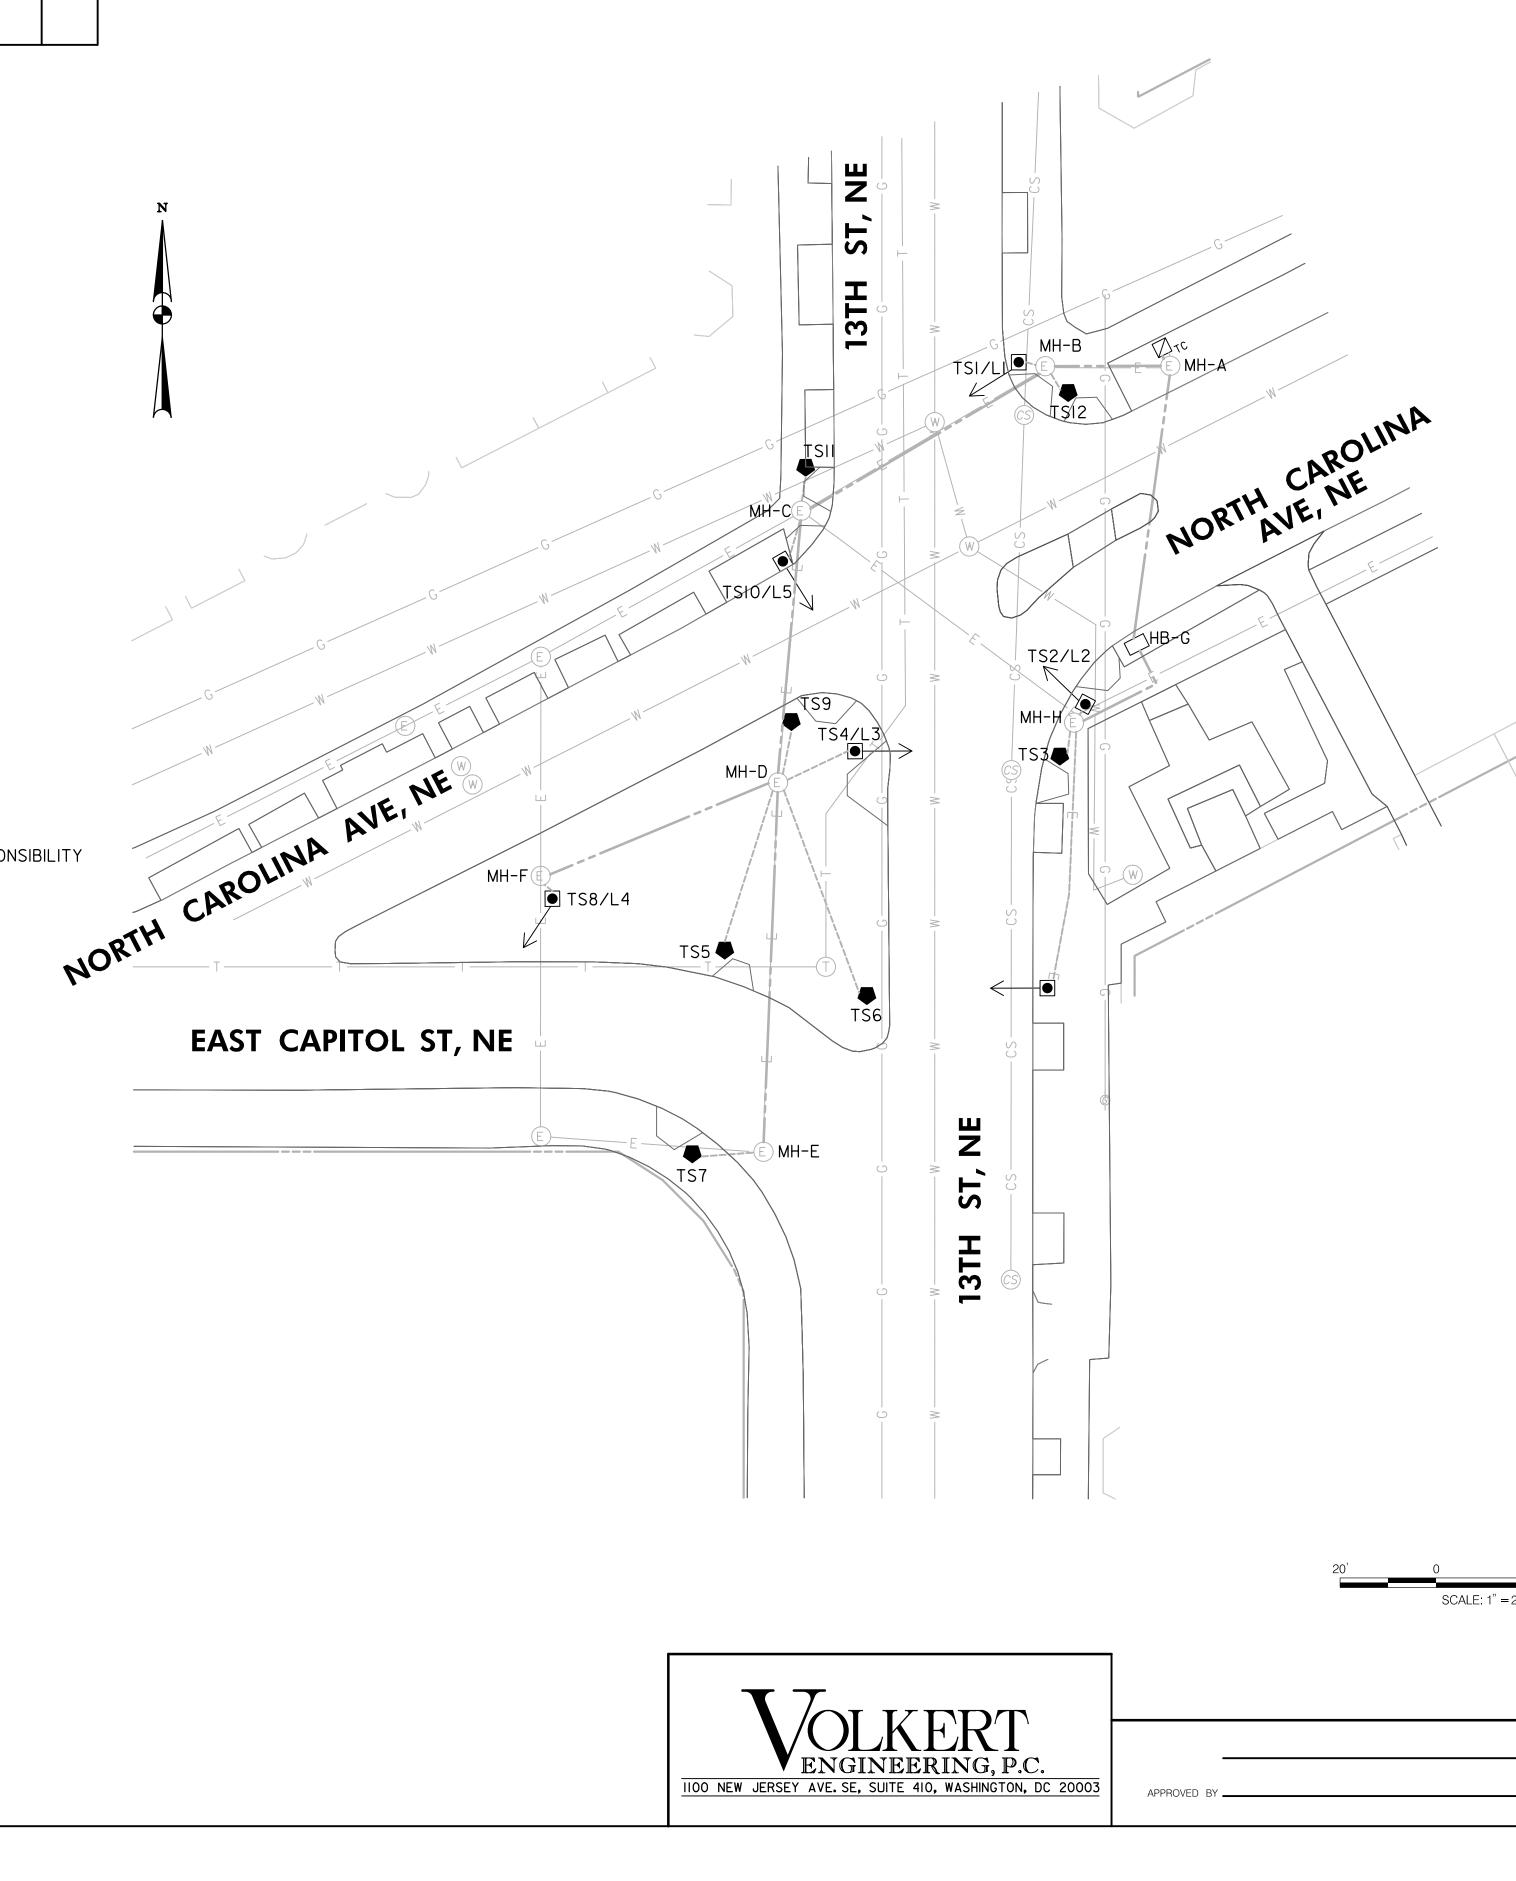
EXISTING CONDUIT SIZE AND TYPE ARE NOT AVAILABLE FOR THESE CONNECTIONS.

			SG - 3					
			ACISA					
SEQUENCE	E OF OPERATION DRAWING NO. TS 16	603–D	3115					
	DISTRICT OF COLUMBI ARTMENT OF TRANSPOR	TATION	FINAL					
TRAFFIC ENGINEERING AND SIGNALS DIVISION								
10	3TH STREET, EAST CAPITOL STREE NORTH CAROLINA AVE., NE.	T, AND	DESIGNED BY					
	DRAWN BY CW/JG/JCS							
SUBMITTED:	TRAFFIC SIGNAL PROJECT ENGINEER	DATE	REVIEWED BY HT					
	TRAFFIC SIGNAL FRODECT ENGINEER	DATE	DATE IO/22					
RECOMMENDED	TRAFFIC SIGNAL DESIGN PROJECT MANAGER	DATE	SCALE " = 20'					
	ITS / TRAFFIC SIGNAL MAINTENANCE DIVISION MANAGER	DATE	SHEET OF 2 3					
 APPROVED	TRAFFIC SIGNAL PROGRAM MANAGER	DATE	DRAWING NO. S-2126-C					

REVISION								
DESCRIPTION	DATE	COR.	CHK.	APP.	APP.	APP.	APP.	APP.

GENERAL NOTES:

- I. THE LOCATION OF UTILITIES SHOWN ON THE PLANS ARE BASED ON FIELD SURVEY DATA AND/OR RECORD DRAWINGS. THE LOCATION OF UTILITIES SHOWN IS APPROXIMATE AND THE INFORMATION SHOWN IS NOT NECESSARILY COMPLETE. IT SHALL BE THE RESPONSIBILITY OF THE CONTRACTOR TO VERIFY THE EXISTENCE OF ALL UTILITIES WELL IN ADVANCE OF CONDUCTING CONSTRUCTION OPERATIONS WHICH COULD DAMAGE THESE FACILITIES. IN AREAS WHERE PROPOSED CONSTRUCTION MAY CONFLICT WITH EXISTING UTILITIES, THE CONTRACTOR SHALL TAKE ALL NECESSARY PRECAUTIONS TO AVOID DAMAGE TO EXISTING UTILITIES. IF A UTILITY IS DAMAGED, THE CONTRACTOR SHALL IMMEDIATELY NOTIFY THE ENGINEER AND THE OWNER OF SAID UTILITY. ANY DAMAGE SUSTAINED TO UTILITIES ABOVE OR BELOW THE GROUND SHALL BE REPAIRED BY OR UNDER THE DIRECTION OF THE OWNER AT CONTRACTOR'S EXPENSE. UNDER NO CIRCUMSTANCE SHALL THE CONTRACTOR BACKFILL AN EXCAVATION AFFECTING SAID UTILITY WITHOUT FIRST RECEIVING PERMISSION FROM THE UTILITY OWNER.
- 2. THE CONTRACTOR SHALL EXCAVATE AND LOCATE VERTICALLY AND HORIZONTALLY ALL UTILITIES IN CLOSE PROXIMITY TO THE PROPOSED TRAFFIC SIGNAL WORK AREA AS NECESSARY FOR CONSTRUCTION.
- 3. THE CONTRACTOR SHALL NOTIFY MISS UTILITY AT I-800-257-7777, 48 HOURS PRIOR TO EXCAVATING.
- 4. THE CONTRACTOR SHALL MAINTAIN A MINIMUM 2 FOOT HORIZONTAL CLEARANCE TO ALL UTILITIES DURING CONSTRUCTION.
- 5. CONTRACTOR SHALL FURNISH AND INSTALL ALL PROPOSED CONDUITS.
- 6. THE UTILITY COMPANY WILL REQUIRE A CONNECTION CHARGE FOR EACH TRAFFIC SIGNAL CONNECTION. THE COST FOR THIS CHARGE IS THE RESPONSIBILITY OF THE PERMITTEE OR HIS CONTRACTOR.

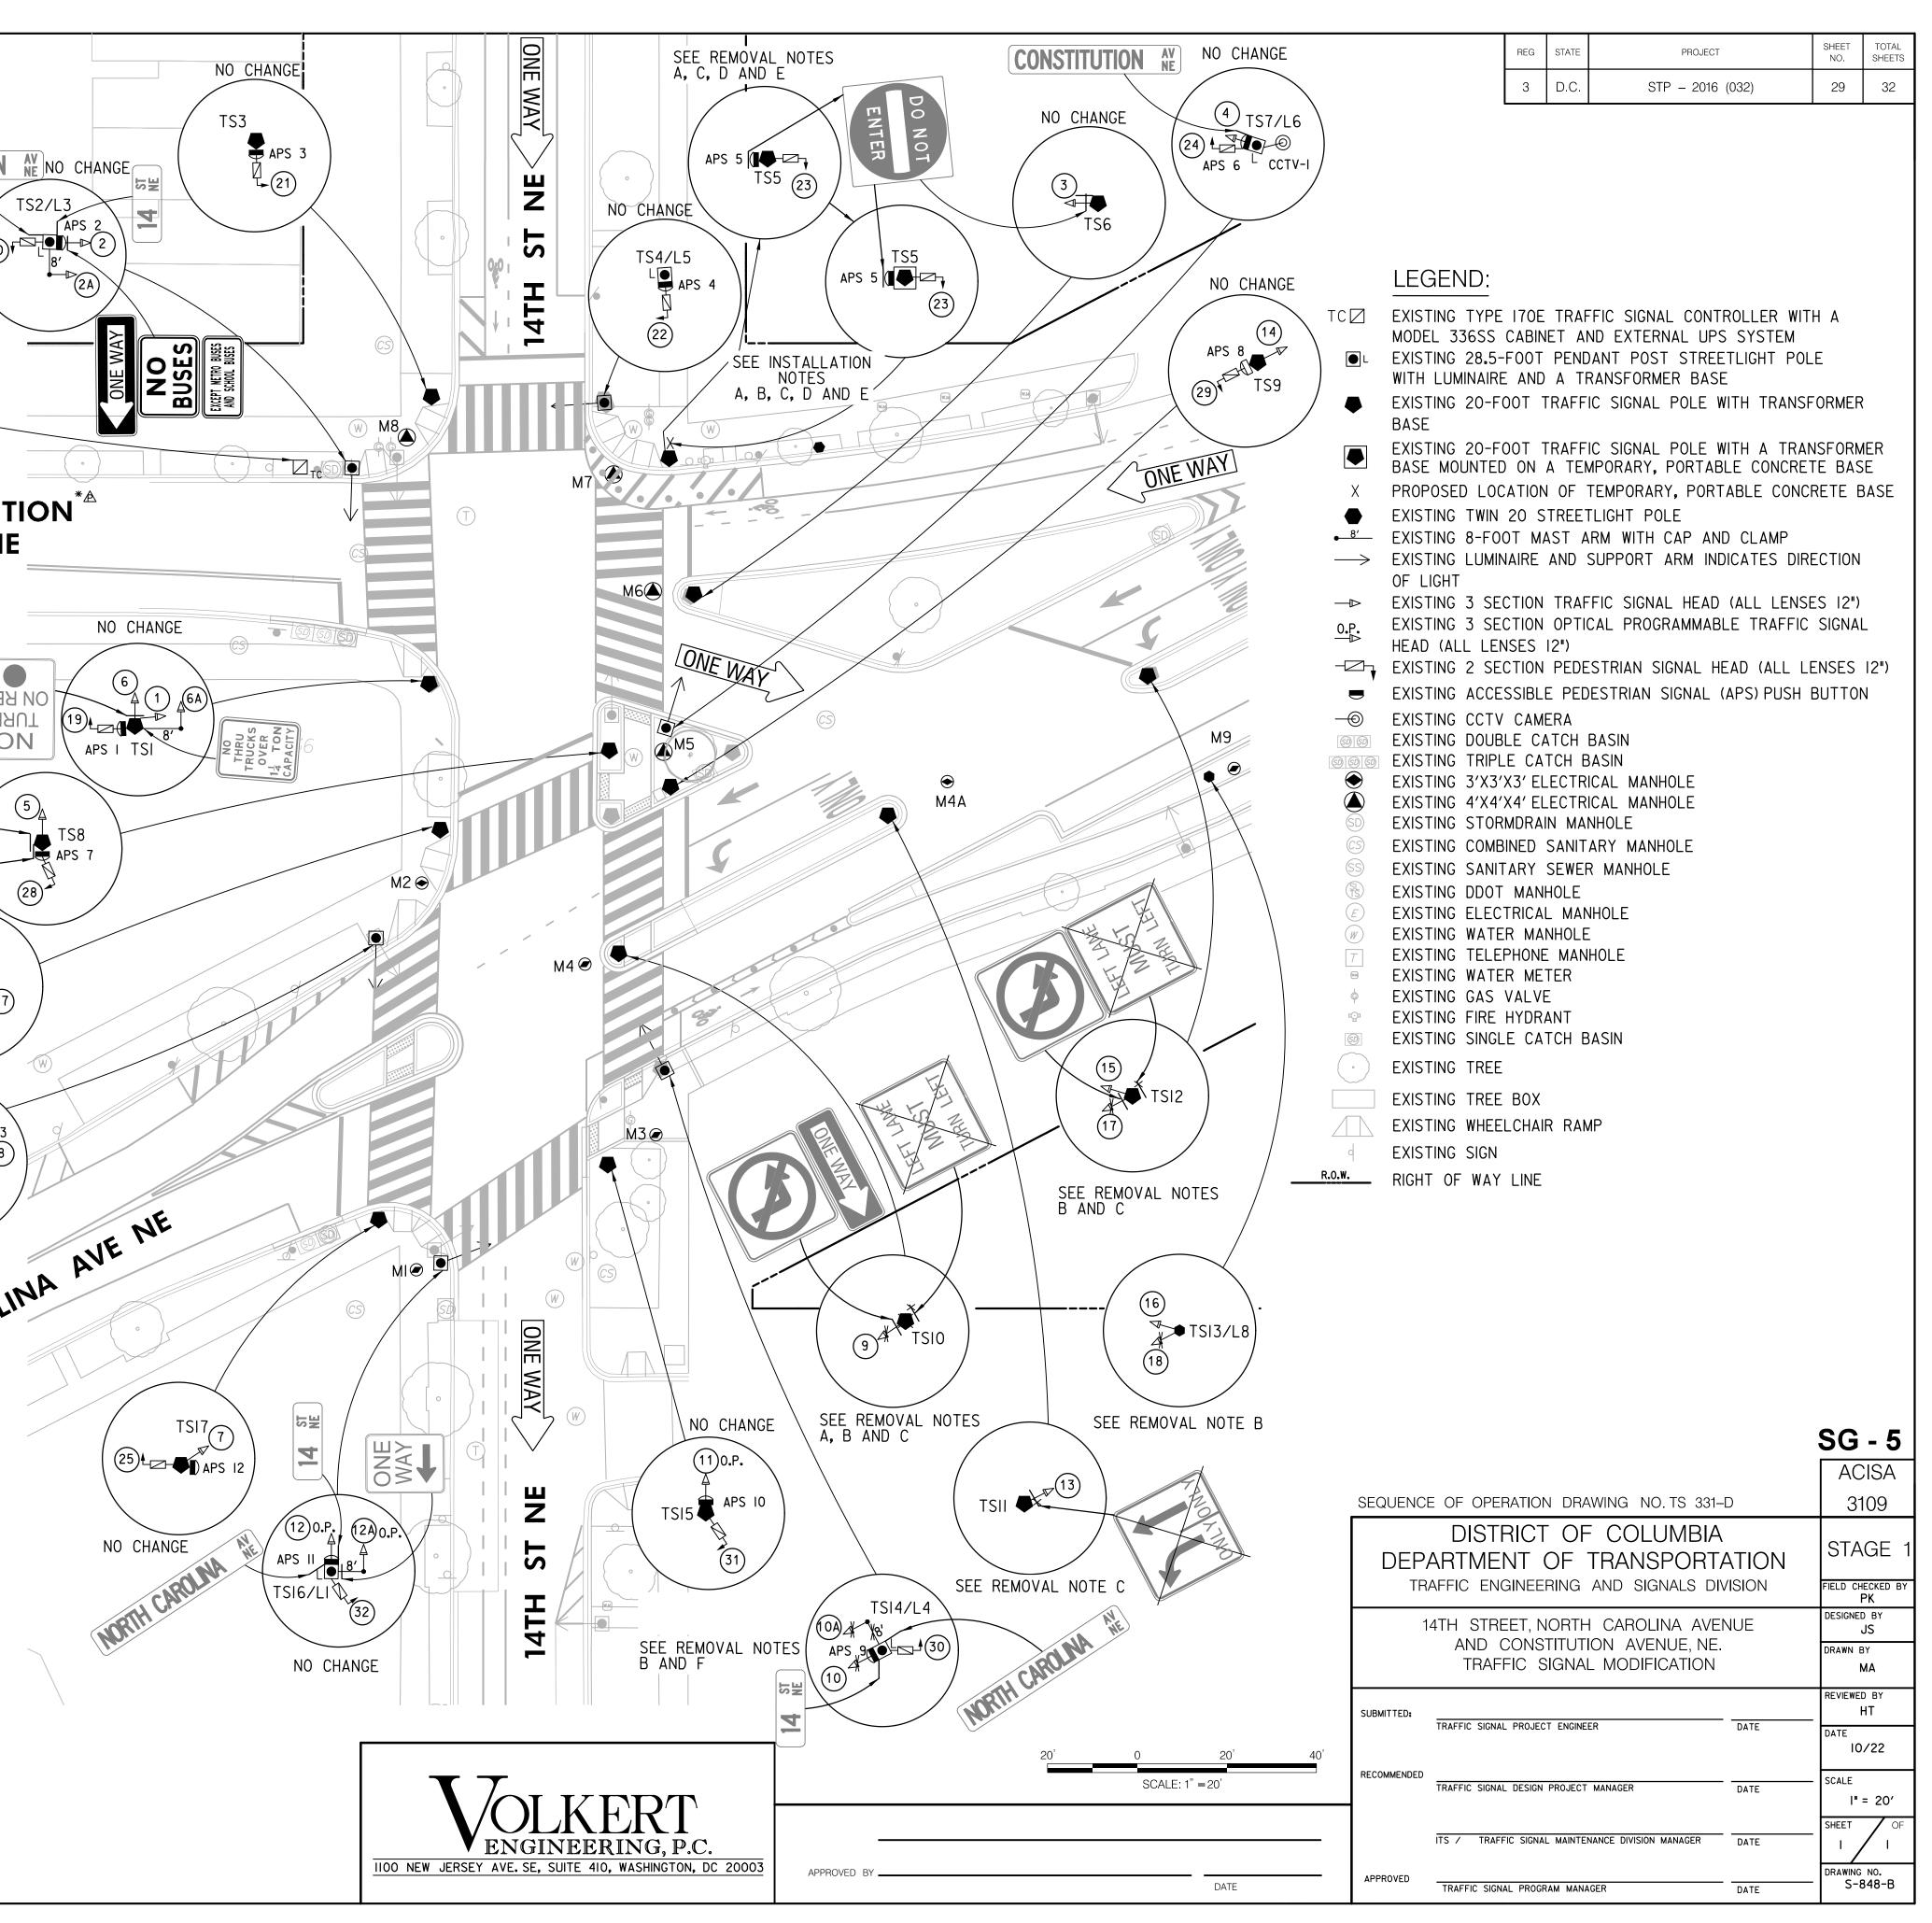


		REG	STATE	PROJECT	SHEET NO.	TOTAL SHEETS				
		3	D.C.	STP – 2016 (032)	28	32				
	LEGEND:									
TC 🗌	MODEL 336SS	CABIN	IET AI	FIC SIGNAL CONTROLLER WIT ND EXTERNAL UPS SYSTEM OANT POST STREETLIGHT POL						
<u>●</u>	WITH LUMINAIRE	E AND	A TI	RANSFORMER BASE						
 ● ▲ *▲ 	EXISTING 3'X3'X3' ELECTRICAL MANHOLE EXISTING 4'X4'X4' ELECTRICAL MANHOLE EXISTING LOCATION FOR PEPCO POWER CONNECTION									
SD CS SS	EXISTING STORMDRAIN MANHOLE EXISTING COMBINED SANITARY MANHOLE EXISTING SANITARY SEWER MANHOLE									
	EXISTING DDOT MANHOLE EXISTING ELECTRICAL MANHOLE EXISTING WATER MANHOLE EXISTING TELEPHONE MANHOLE									
 B C	EXISTING WATE EXISTING GAS EXISTING FIRE	R ME VALVE	TER E							
©) (•)	EXISTING SINGL EXISTING TREE	E CA	TCH E	SASIN						
	EXISTING TREE	BOX								
	EXISTING WHEEL		R RAN	<i>I</i> P						
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- 6	EXISTING GAS I	UIILII	t LIN	IE						

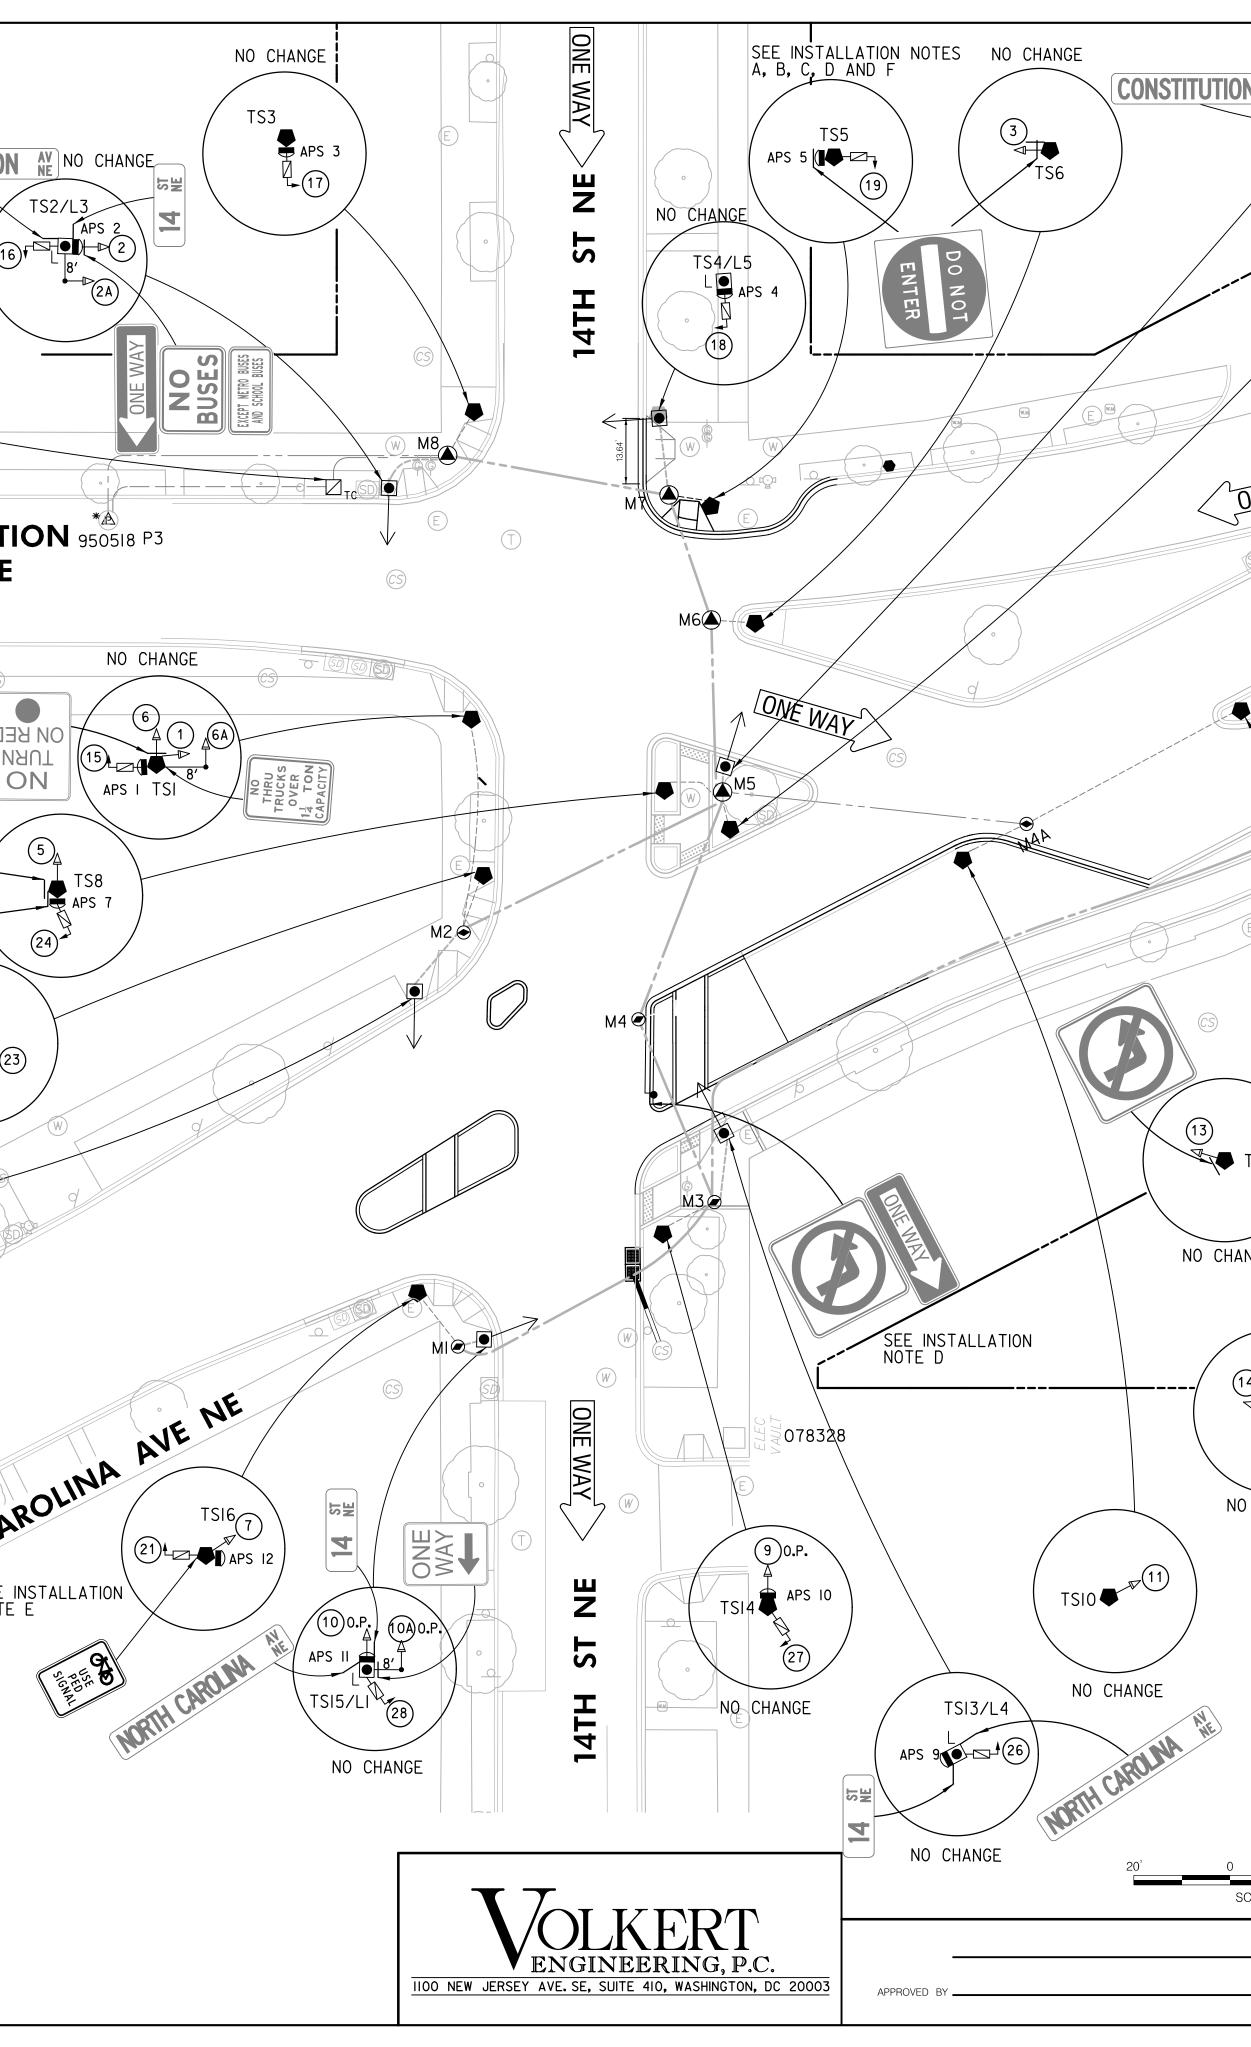
		SG - 4							
		ACISA							
	SEQUENCE OF OPERATION DRAWING NO. TS 1603-D	4228							
	DISTRICT OF COLUMBIA DEPARTMENT OF TRANSPORTATION TRAFFIC ENGINEERING AND SIGNALS DIVISION								
	13TH STREET, EAST CAPITOL STREET, AND NORTH CAROLINA AVENUE, N.E.								
	TRAFFIC SIGNAL MODIFICATION UTILITY PLAN								
	SUBMITTED: TRAFFIC SIGNAL PROJECT ENGINEER DATE	REVIEWED BY							
		DATE IO/22							
	RECOMMENDED TRAFFIC SIGNAL DESIGN PROJECT MANAGER DATE	SCALE " = 20'							
	ITS / TRAFFIC SIGNAL MAINTENANCE DIVISION MANAGER DATE	SHEET OF 3							
	APPROVED TRAFFIC SIGNAL PROGRAM MANAGER DATE	DRAWING NO. S-2126-C							

20' 20'		Z
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	DESCRIPTION	REVIS DATE	ON COR.	СНК.	APP.	APP.	APP.	APP.	APP.	N		
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	ERAL NOTES: 		- ^ 1 1 ^ -	ΓΙΟΝ	ος τυ	e tra			NO	CHANGE		
Α.	SIGNALS SHALL CONFORM W OF THE LATEST VERSIONS	ITH AF OF DDC	PROP	RIATE ANDAR	PROV	ISION CIFIC					\backslash	
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с.	PROCUREMENT. THE CONTRACTOR SHALL FU CONCRETE BASES, TRAFFIC	RNISH	ALL	ТЕМРО	RARY,	PORT		,				
D.	PEDESTRIAN SIGNAL HEADS MOUNTING HARDWARE.	, TRAN	ISFORI	MER B		AND A					NSTIT	I I T
	SIGNAL EQUIPMENT TO THE	DDOT LEAST	SIGN/ 72 H	AL SH DURS	OP. C IN AD	ONTAC					AVE	
E.	IF THE EXISTING PEPCO P CONTRACTOR SHALL CONTAC AND PAY FEES.	OWER 1	S TO	BE M	ODIFI NGE S		THE CE					
F.	THE CONTRACTOR SHALL RE POLES TO TEMPORARY POLE OTHERWISE ON PLAN.					EXIST	「ING					
G.	NO ABOVE GROUND HARDWAR A MINIMUM 4' CONTINUOUS MAINTAINED.	E WILL PATH	BE F FOR /	PLACE Ada p	D SUC URPOS	H THA Es is	AT 5 NOT					BED
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Ι.	UNLESS POLES ARE PROPER THE CONTRACTOR IS RESPO ALIGNMENT AND OPERATION	NSIBLE	FOR	MAIN							NO CHANG	
J.	POLES. NO TEMPORARY CABLES SHA TEMPORARY CABLING SHALL	BE PF	ROPERI	Y EN	CLOSE	DIN				ONEV	ST	
Κ.	FLEX CONDUIT AND SHALL EMERGENCY REPLACEMENT B THE CONTRACTOR SHALL BE	E REQL RESPO	JIRED DNSIBL	_E FO	R THE	PERM				WAY	4	
·	CURBS, SIDEWALKS, LANDS CONSTRUCTION AND AT THE	END C	G IRR DF COM	IGATI NSTRU	ON AR CTION	EAS E)UR I N(•			TSI9	\sim
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1.	DDOT PERSONNEL WILL MAK INSIDE THE CONTROLLER C MAKE ALL ELECTRICAL CON	ABINET	• THE	E CON	TRACT	OR SH	ONS IALL			TSI	8/L2 AP	S 13 >(8)
2.	PEDESTRIAN SIGNAL HEADS TEMPORARY SIGNAL CABLES SURFACE SHALL BE PROTEC	Exten	IDING	OVER	THE	GROUN	ID		NO CHA			\mathbf{Y}
3.	CONDUIT. THE CONTRACTOR SHALL PR COILED NEATLY AT EACH T	OVIDE	50 FE	ET O	F SLA	СК СА				ANE		Y
ΙΝΙςτ	ALLATION NOTES:			, , , , ,)	*	2,101		rent	CARO	ORTH		1
A.	INSTALL RELOCATED 20' 1				OLE (ONTO					CARC	つい
B. C.	A TEMPORARY, PORTABLE, INSTALL RELOCATED TRAFF INSTALL RELOCATED PEDES	IC SI STRIAN	GNAL SIGN	HEAD(AL HE).			N	ORTH		
D. E.	INSTALL RELOCATED TRAFF INSTALL RELOCATED APS F								1.			
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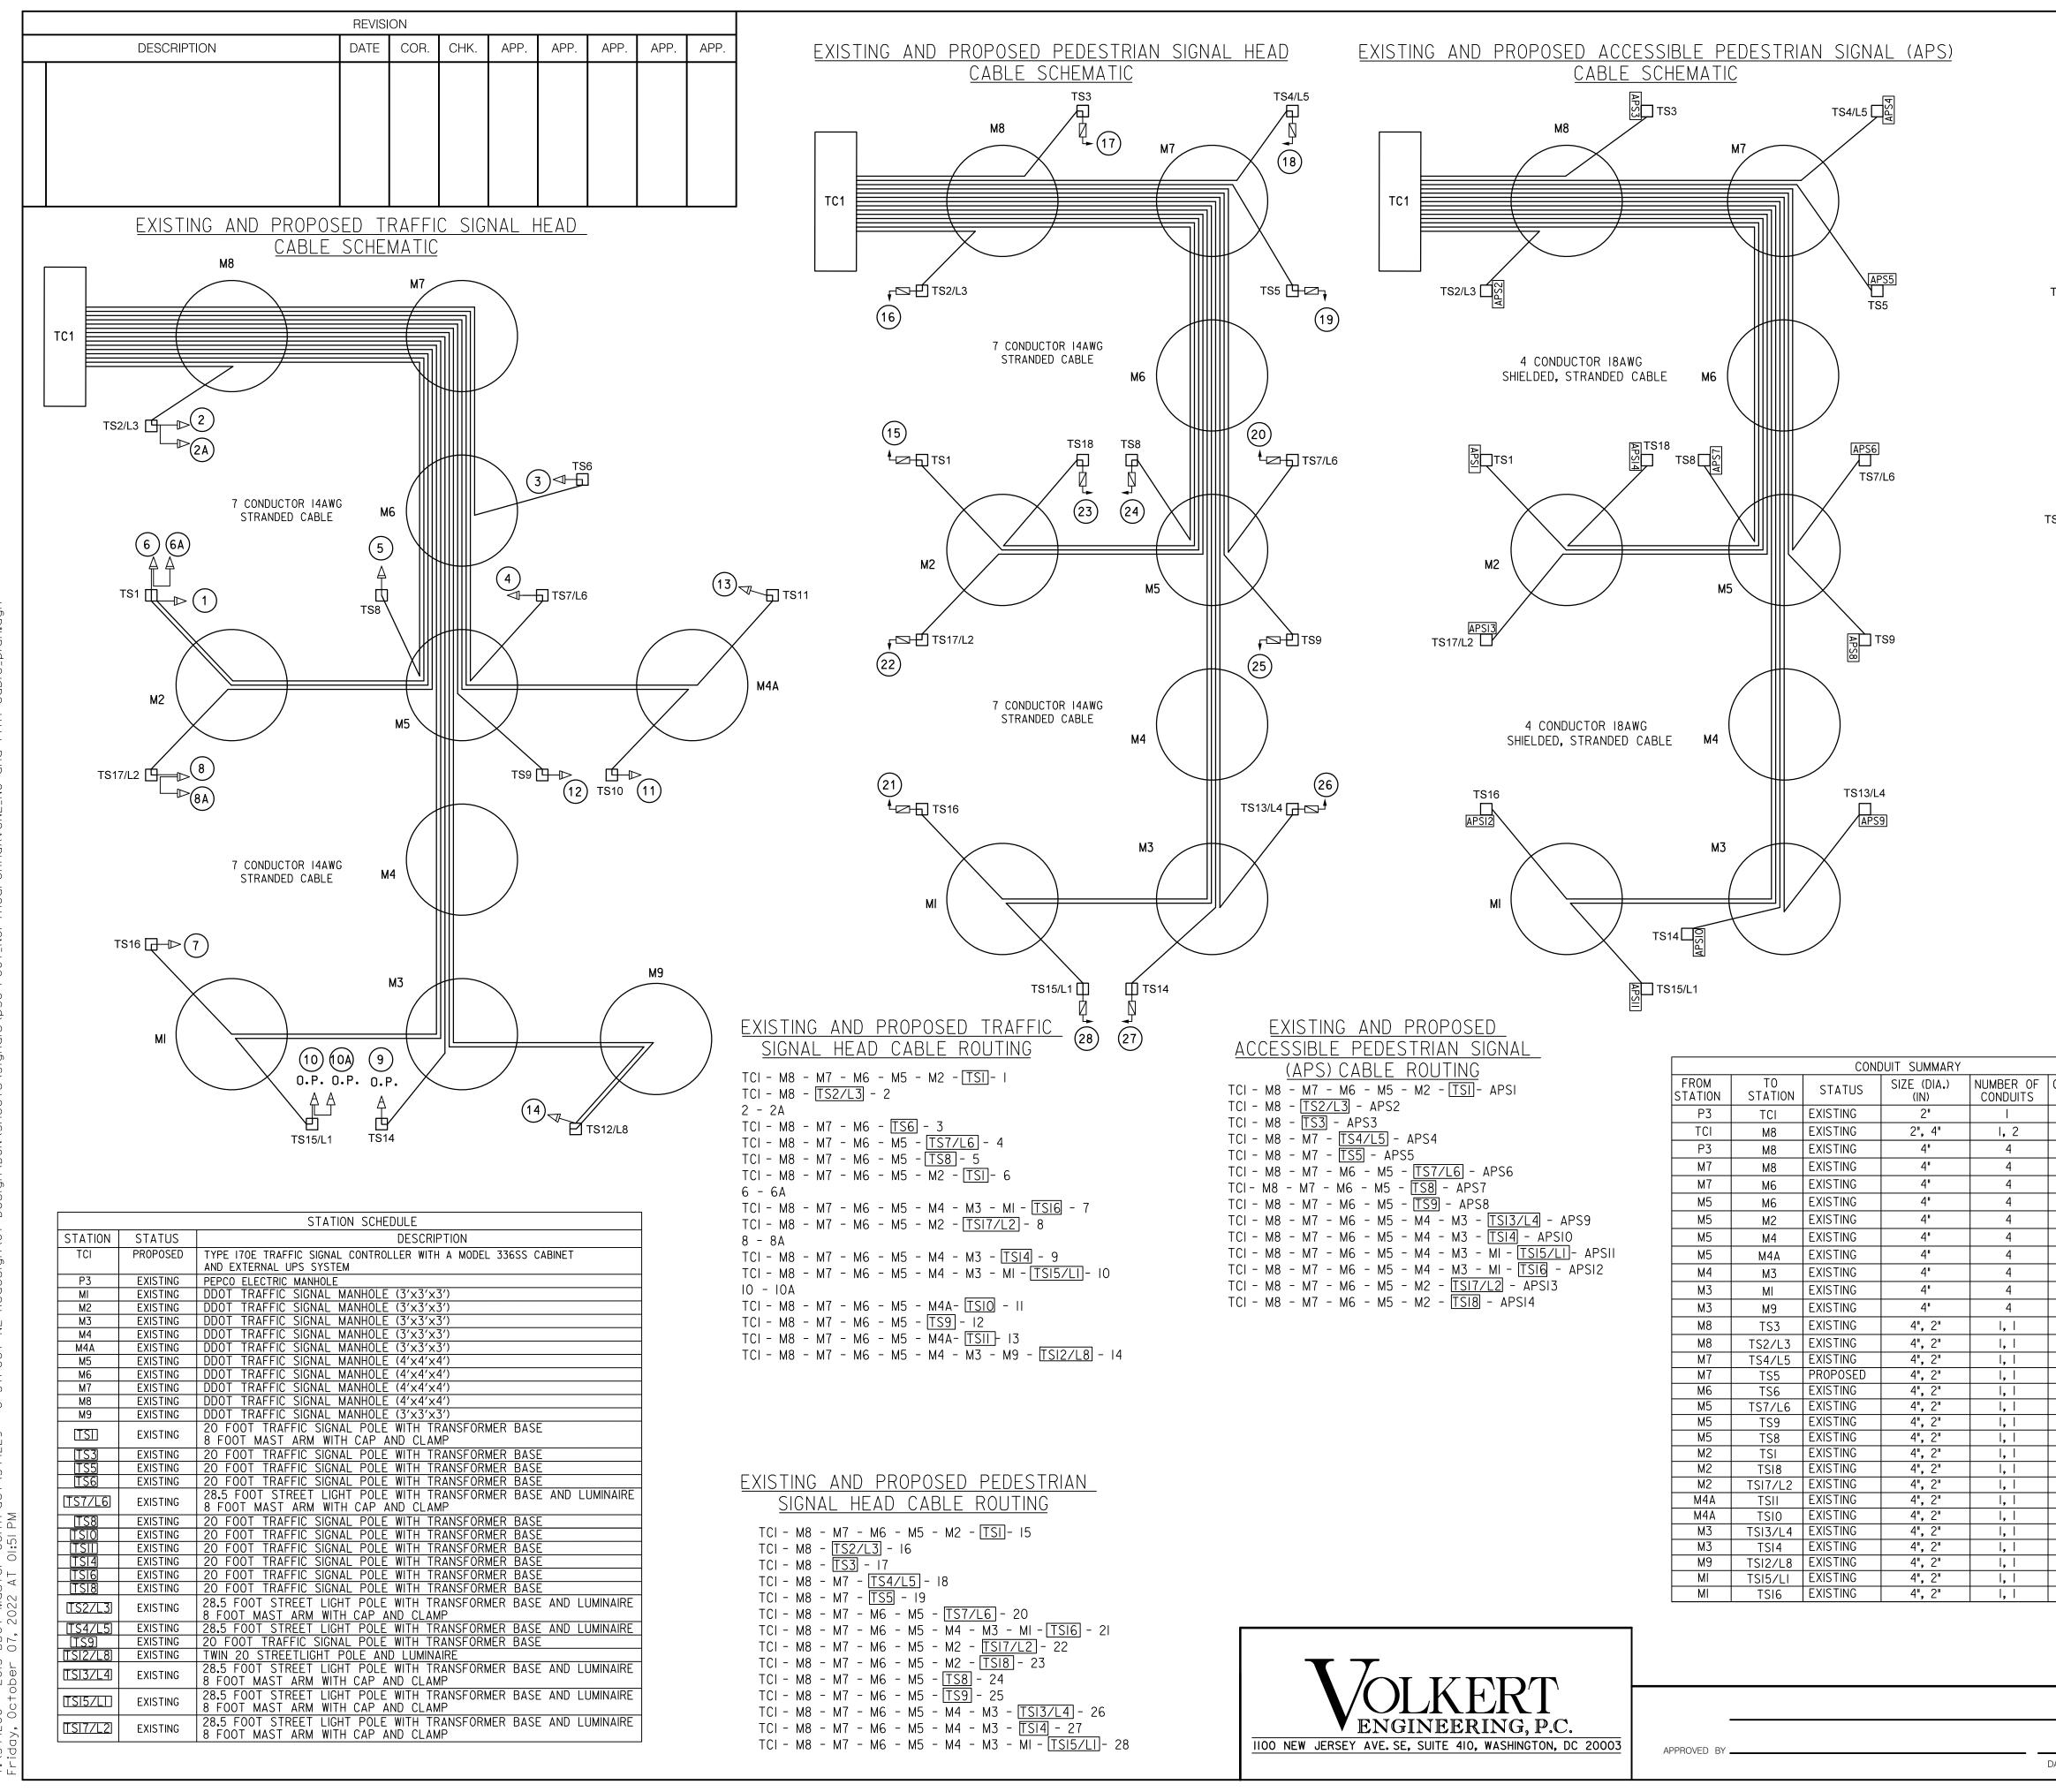


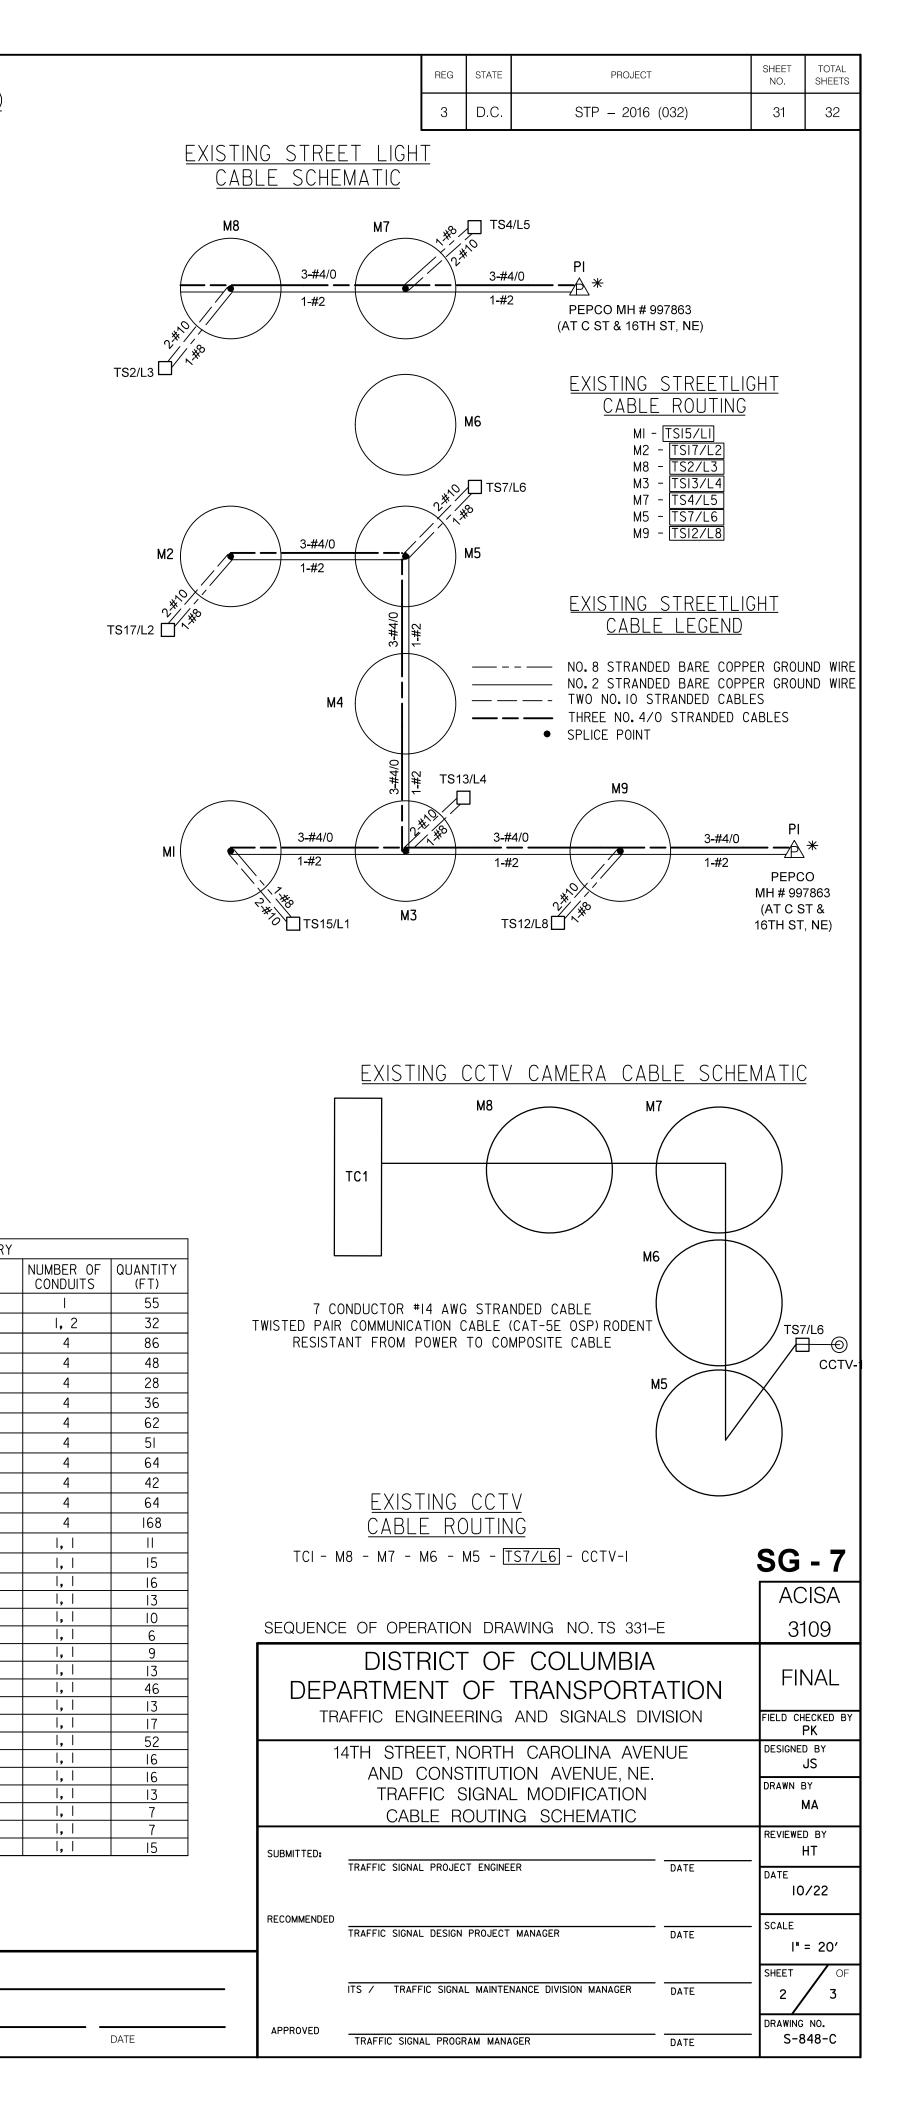
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╞	DESCRIPTION	DATE	COR.	CHK.	APP.	APP.	APP.	APP.	APP.	
	GENERAL NOTES:									
	A.ALL WORK RELATING TO THE II SHALL COMPLY WITH APPROPRI	ATE PI	ROVISIC	NS OF	THE	ATES	Γ		/	NO CHANGE
	VERSIONS OF DDOT STANDARD AND THE CONTRACT SPECIAL F	PROVISI	ONS.							FRONT
	B. THE CONTRACTOR SHALL SUBM EQUIPMENT AND MATERIALS TO WRITTEN APPROVAL FROM DDO	BE F	URNISH	ED AN	D INST	ALLED				
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	CABINET FOUNDATION. E. THE CONTRACTOR SHALL FURN		·				AND			
	PEDESTRIAN SIGNAL HEADS, TR BASES, APS UNITS, TRAFFIC SI									Ē
-plan.dgn	ALL MOUNTING HARDWARE. F. THE CONTRACTOR SHALL REMO POLES, CONTROLLER AND HARE									
al _pl a	PORTABLE, CONCRETE BASES, POLE (IF ANY) AND THE PEDES	AS WE	LL AS	THE E	XISTIN	G PEDE	STAL			
th final.	MOUNTED ON IT. G. THE CONTRACTOR SHALL REMO	VE AL	L EXIS	TING T	EMPOR	ARY,				NO CHANGE
and 14th	PORTABLE, CONCRETE BASES. H. THE CONTRACTOR SHALL RETU									
	EQUIPMENT TO DDOT TRAFFIC COPPER 72 HOURS IN ADVANCE SERVICE.									YAW A NAW
IdAven	I. NO ABOVE GROUND HARDWARE SUCH THAT A 4 FEET CLEAR									
Carolir	PURPOSES. J. A NEW PEPCO ELECTRICAL SEF							0	NO	CHANGE TSI8
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P006_1	MAST ARM NOTES:								ST	
s/pSG-	A. A BACK PLATE SHALL BE AFFI ARM MOUNTED SIGNAL HEAD. B. THE BOTTOM OF MAST ARM M								4	TSI7/L2 APS 13
Signal	SHALL BE IG FEET ABOVE THE C. AN ASTRO-BRAC OR APPROVED	ROAD	WAY S	URFAC	Ε.			NO CH	ange (
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JGN/Sh	INSTALLATION NOTES						, c'	ROLN		Z Z
sign/DGN/	A. INSTALL RELOCATED EXISTING 2	-	TRAF	FIC SIG	NAL PO		Allt			03
NO7 De	WITH A TRANSFORMER BASE. B. INSTALL RELOCATED EXISTING LI C. INSTALL RELOCATED EXISTING A									
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NE Rea	E. INSTALL PROPOSED TRAFFIC SIG F. INSTALL PROPOSED 15 IN.BOLT	CIRCLE								ROL
treet	BASE PER DDOT STANDARD DRA MOUNTED PENDANT POLE).	WING 6	14.07 (ΤΥΡΙϹΑΙ	_ GROU	ND				NORTH SEE INSTAL
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Contract/34422 :51 PM	CABLE NOTES:									S. G. M.
Contr 1:51 PM	A. DDOT PERSONNEL WILL MAKE A INSIDE THE CONTROLLER CABIN	ET. TH	E CONT	FRACTO	DR SHA	LL MA	KE			
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DDOT Ma 07, 2022	7C I4AWG STRANDED CABLE TO SIGNAL HEADS.									
2013 DE	C. THE CONTRACTOR SHALL FURN SHIELDED 4C 18AWG STRANDED	CABLI	ES TO	ALL A	PS UN	ITS. A	SEGME	INT		
0	OF 4C I8AWG SHIELDED, STRAN Each pole mounted aps unit signal head mounted on the	T TO T	THE 2-	SECTIO						
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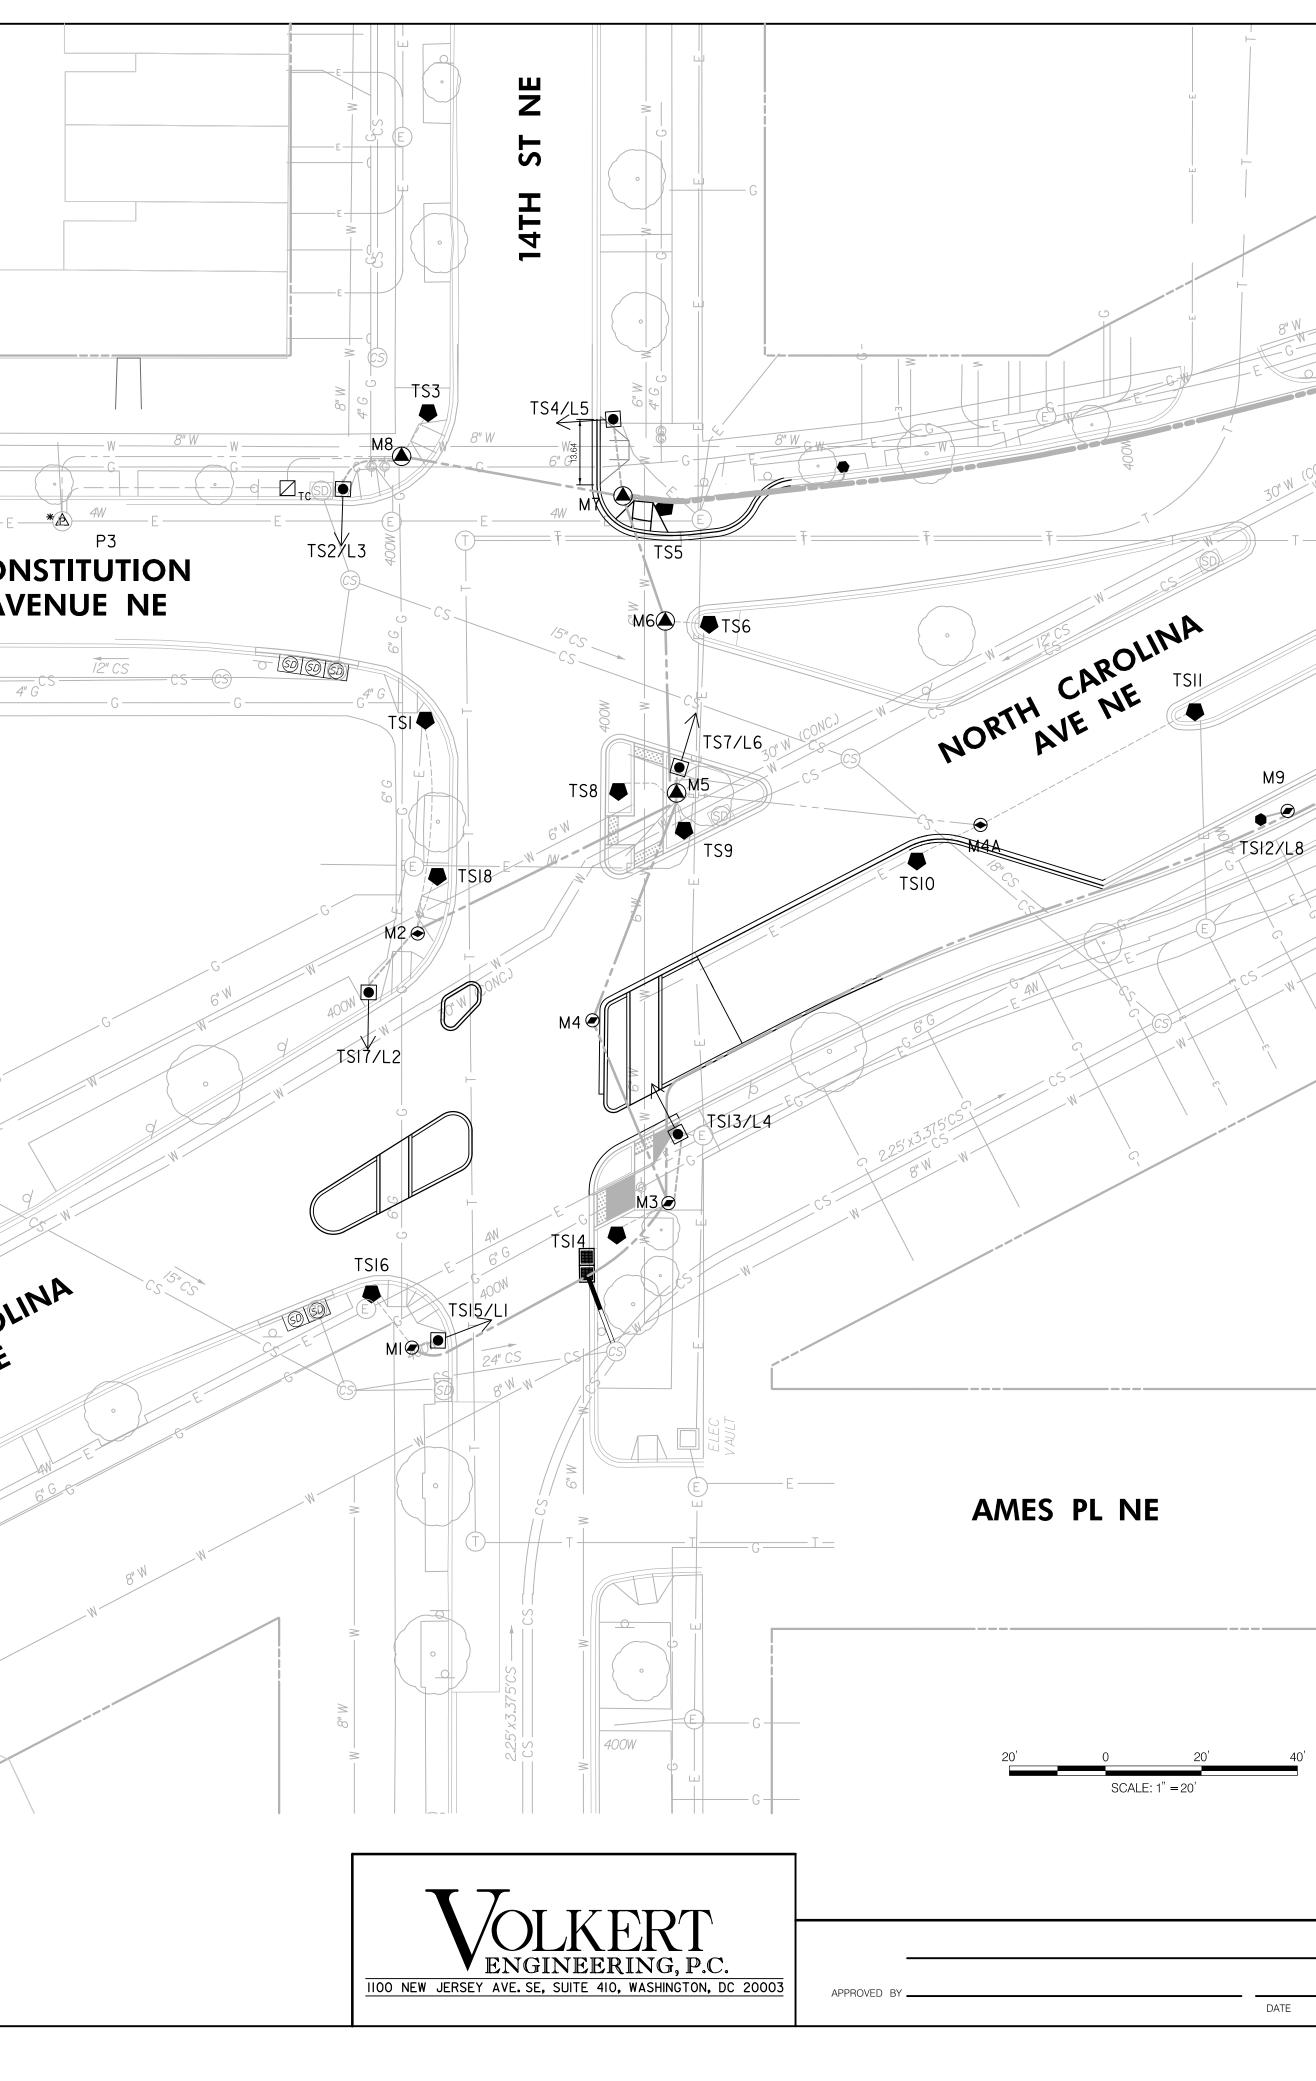
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	GENERAL NOTES:										
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	14	4TH STREET, NORTH CAROLINA AVE AND CONSTITUTION AVENUE, NE TRAFFIC SIGNAL MODIFICATION UTILITY PLAN		DESIGNED BY JS DRAWN BY MA
	SUBMITTED:	TRAFFIC SIGNAL PROJECT ENGINEER	DATE	REVIEWED BY HT DATE
	RECOMMENDED	TRAFFIC SIGNAL DESIGN PROJECT MANAGER	DATE	10/22 SCALE " = 20'
]	ITS / TRAFFIC SIGNAL MAINTENANCE DIVISION MANAGER	DATE	SHEET OF
	APPROVED	TRAFFIC SIGNAL PROGRAM MANAGER	 	DRAWING NO. S-848-C